Date: Description: 14.05.25 DA ISSUE





# PROPOSED SHOP TOP HOUSING (STRATA)

**CLIENT: CENITIC** 

**STATUS:** DA ISSUE DRAFT

**LOT No:** 1 **DP No:** 925163

STREET: 99 ISABELLA ST, WINGHAM

**CWC JOB #:** A5989


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1	LEGENDS	G
2	SITE PLAN	G
3	S68 & S138 PLAN	G
4	LOWER FLOOR PLAN - EXISTING	G
5	UPPER FLOOR PLAN - EXISTING	G
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7	UPPER FLOOR PLAN	G
8	ELEVATIONS	G
9	ELEVATIONS	G
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11	ROOF PLAN	G
12	GLAZING	G
13	DRAFT SUB-DIVISION PLAN	G
14	INDICATIVE LANDSCAPE PLAN	G
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## GENERIC | TYPICAL KEY, LEGEND AND ABBREVIATIONS FOR COLLINS W COLLINS ARCHITECTURAL PLANS

THESE NOTES MUST BE READ AND UNDERSTOOD BY ALL INVOLVED IN THE PROJECT. THIS INCLUDES (but is not limited to): OWNER, BUILDER, SUB-CONTRACTORS, CONSULTANTS, RENOVATORS, OPERATORS, MAINTAINERS, DEMOLISHERS. PLEASE USE THIS IN CONJUNCTION WITH ALL DRAWING SHEETS AND VIEWS CONTAINED FORTHWITH IN THIS PLAN SET. REVISED JANURARY 2021

#### SYMBOLS AND LINES



collins w collins  Building Designers

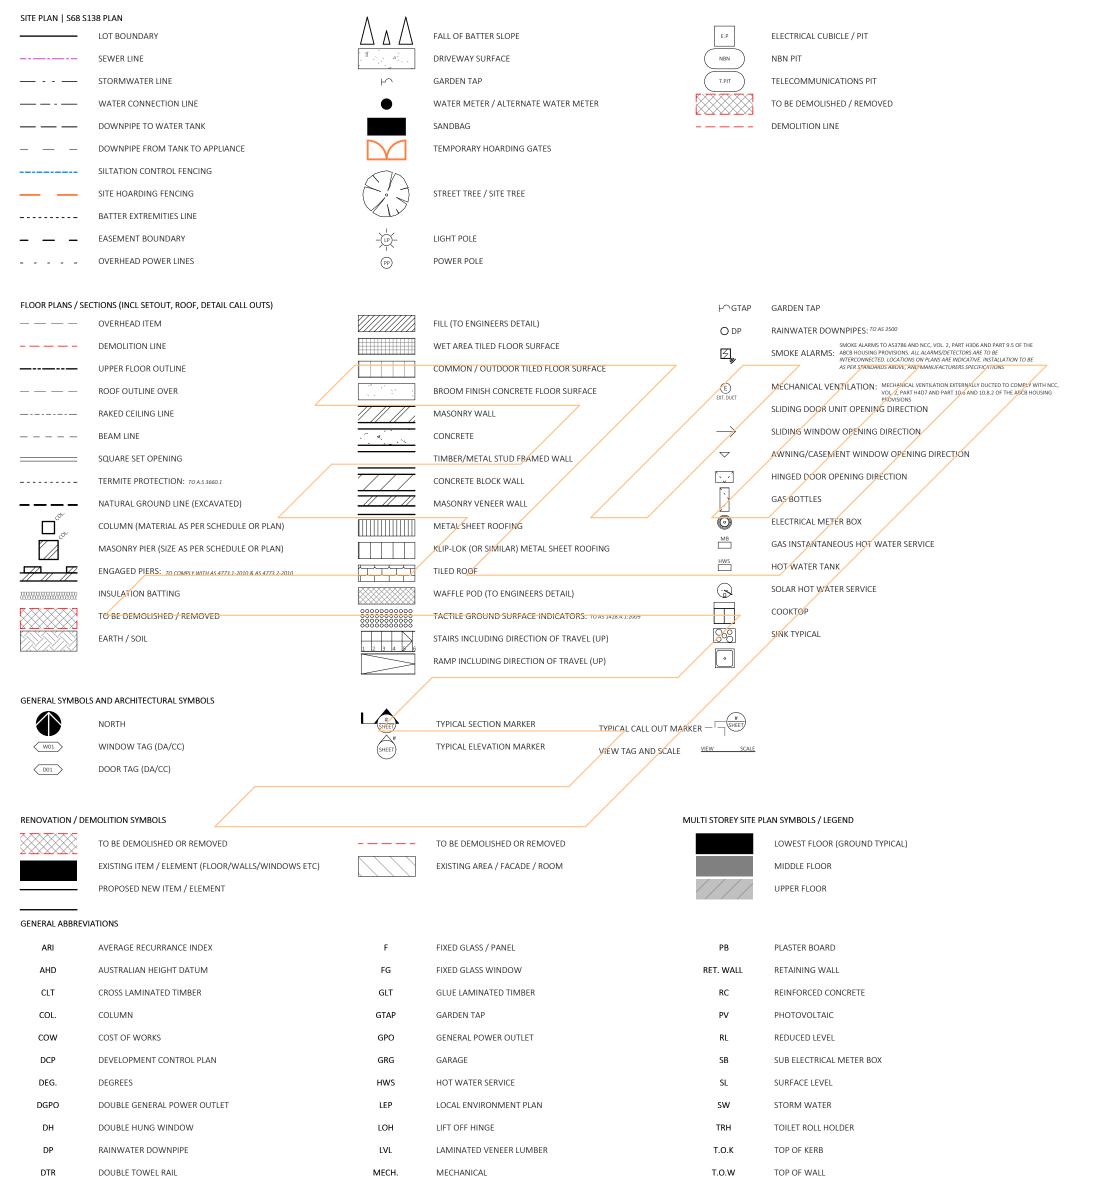HOT WATER SERVICE

FINISHED SURFACE LEVEL

FIBRE CEMENT

HWS

FC

F.S.L

copyrig DO NO check a

Designer prior to commencement of work.

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onic, mechanical, photocopying, recording or wise, without the prior permission of the	STATUS: DA	ISSUE DRAFT	CLIEFT.	1 OF 17
ight holders.  OT SCALE from this drawing. CONTRACTOR is to	LOT No: 1	DP No: 925163	SHEET:	1 011
all the dimensions on the job prior to necement of shop drawings or fabrication.	STREET: 99 I	SABELLA ST, WINGHAM	1	

MB

 $\mathsf{MR}$ 

МН

NGL

ELECTRICAL METER BOX

MOISTURE RESISTANT

NATURAL GROUND LINE

MAN HOLE

	LEGENDS		DRAWING REVISION + NOTES					
			Date:	Revision:	Issue:	Drawn:		
17	SCALE:	1:100	11.03.25	DRAFT DA	E	AE		
1 /	SHEET SIZE:	A3		REV DRAFT DA ISSUE	F G	AE AE		
	START DATE:	09.01.2023						
	DWG No:	A5989						

Certificate No. #HR-BERK5N-01

WWW. COLLINSWCOLLINS.COM.AU

WATER CLOSET

BATH SIZING

VANITY SIZING

INTERIOR DOOR SIZING


WC

1650B

900V

820

**CLIENT:** CENITIC

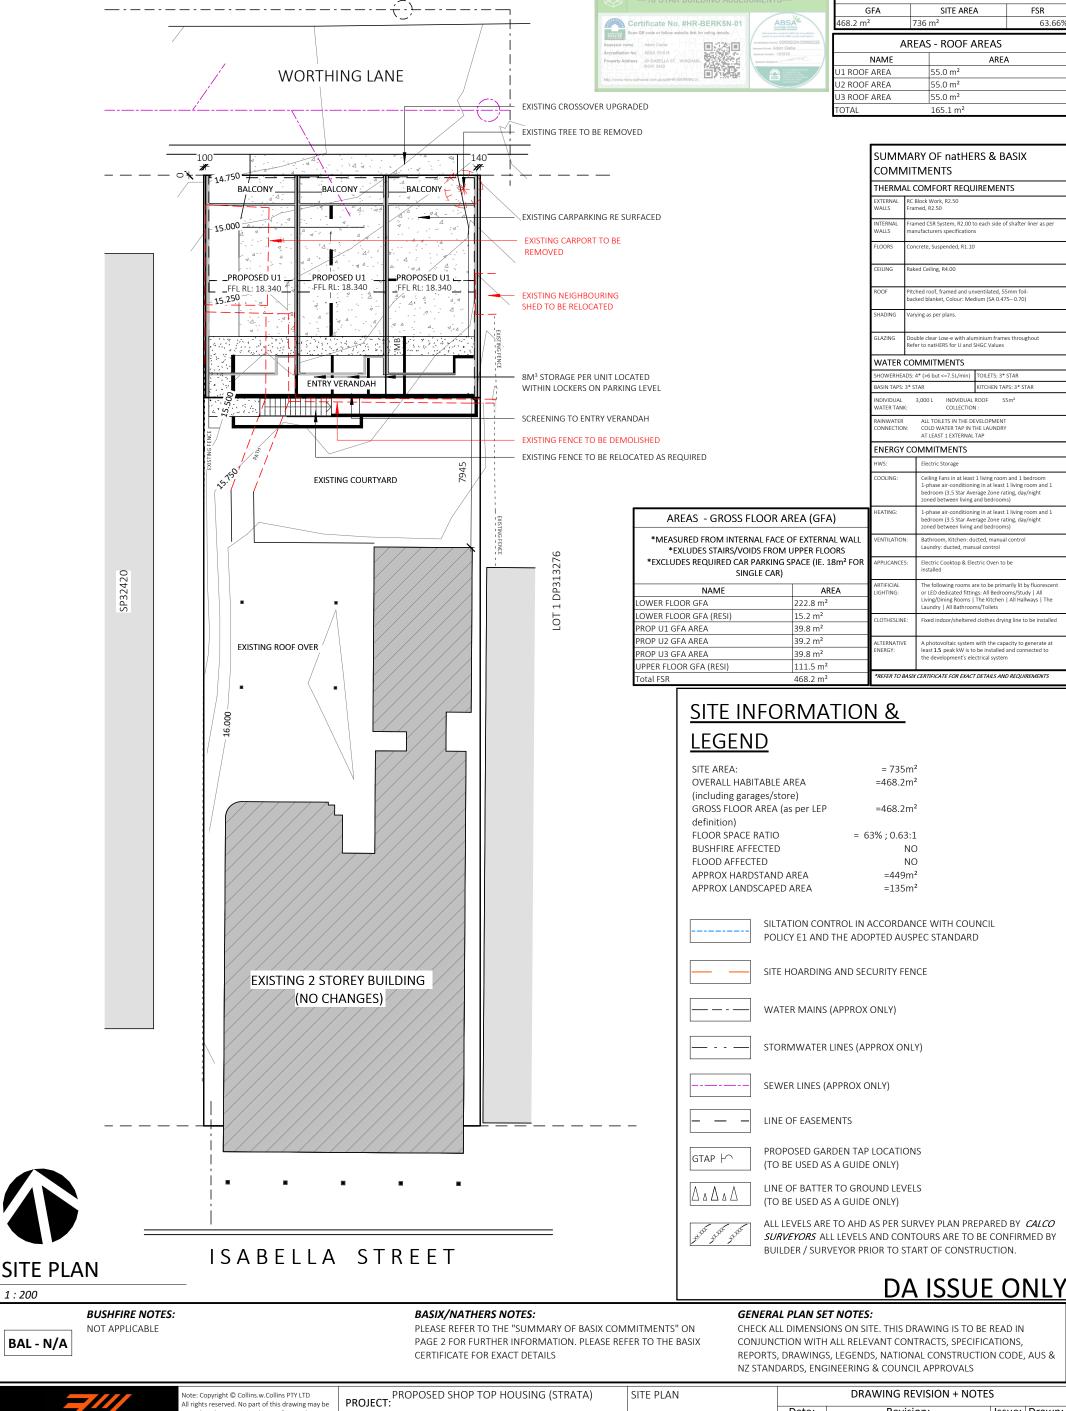

89A Lord Street (PO Box 5667), Port Macquarie nsw 2444 | Shop 17 Centrepoint Arcade, Taree NSW 2430

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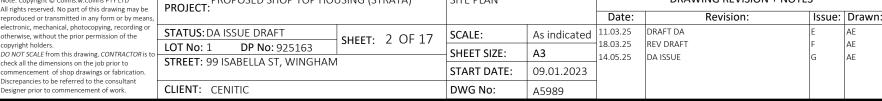
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AREAS - FLOOR SPACE RATIO (FSR)





# CIVIL & STORMWATER WORKS for 99 ISABELLA STREET WINGHAM NSW 2429





**Prepared by** 

# WALLACE INFRASTRUCTURE DESIGN PTY LTD



DRAWING NUMBER	DRAWING DESCRIPTION
C01.01	LEGEND, DRAWING SCHEDULE AND LOCATION PLAN
C02.01	GENERAL NOTES
C04.01	SITE DETAIL PLAN
C04.02	SAFE INTERSECTION SIGHT DISTANCE ASSESSMENT
C05.01	STORMWATER MANAGEMENT PLAN
C06.01	RAINWATER TANK TYPICAL SECTION & DETAILS

# **ABBREVIATIONS**

A/G	ABOVE GROUND	IFC	ISSUED FOR CONSTRUCTION	SV
AGG	AGGREGATE	IFCR	ISSUED FOR CLIENT REVIEW	SW
ARCH	ARCHITECT	IL OIL	INVERT LEVEL	SWP
ASP	ASPHALT	IO	INSPECTION OPENING	THK
BM	BENCHMARK	KIP	KERB INLET PIT	TJ
CAD	COMPUTER AIDED DRAFTING	L	LENGTH	TOW
C-C	CENTRE TO CENTRE	LP	LAMP POST (SURVEY)	TW
CH	CHAINAGE	MAX	MAXIMUM	TYP
CI	CAST IRON	MC	MASS CONCRETE	U/G
CJ	CONSTRUCTION JOINT	MH	MANHOLE	UNO
CL	COVER LEVEL or CENTRE LINE	MIN	MINIMUM	U/S
CO	CLEAN OUT (SUBSOIL)	MISC	MISCELLANEOUS	VC
COG	CHANGE OF GRADE	N	NORTH	VP
CONC	CONCRETE	NRV	NON RETURN VALVE	VR
CTRL	CONTROL	NTS	NOT TO SCALE	W
CR	CROWN	OD	OUTER DIAMETER	WC
CTS	CENTRES	OF	OVERFLOW	WL
D	DEPTH	OH	OVERHEAD	WM
DIA	DIAMETER	PP	POWER POLE	WS
DP	DOWNPIPE	PPE	PERSONAL PROTECTIVE EQUIP.	
DRG	DRAWING	PVC	POLYVINYLCHLORIDE	UNITS
D/S	DOWN STREAM	PV	PRESSURE VENT	mm
DTM	DIGITAL TERRAIN MODEL	PVP	PRESSURE VENT PIPE	cm
EB	EDGE BITUMIN	QA	QUALITY ANALYSIS	m
EX	EXISTING	QTY	QUANTITY	$m^2$
ESL	EXISTING SURFACE LEVEL	R	RADIUS	$m^3$
FH	FIRE HYDRANT	RC	REINFORCED CONCRETE	L/s
FHR	FIRE HOSE REEL	REV	REVISION	ha
FFL	FINISHED FLOOR LEVEL	RL	REDUCED LEVEL	
FGL	FINISHED GROUND LEVEL	RW	RETAINING WALL	
FSL	FINISHED SURFACE LEVEL	SFW	SEALED FLOOR WASTE	
FW	FLOOR WASTE	SL	SURFACE LEVEL	
GA	GENERAL ARRANGEMENT	SMH	SEWER MANHOLE	
Gl	GALVANISED IRON	SMV	SEWER MAIN VENT	

S/S

STD

STOP VALVE STORMWATER PIT THICKNESS TRAVERSE JOINT TOP OF WALL TRADE WASTE **TYPICAL** UNDERGROUND UNLESS NOTED OTHERWISE **UPSTREAM** VITRIFIED CLAY PIPE VENT PIPE VERTICAL RISER WIDTH WATER CLOSET WATER LEVEL WATER METER WASTE STACK <u>UNITS</u> **MILLIMETRES** CENTIMETRES **METRES** 

SQUARE METRES

LITRES PER SECOND

**CUBIC METRES** 

**HECTARES** 


LINETYPES & SYMBOLS GENERAL SITE BOUNDARY \_\_\_\_\_ CADASTRAL BOUNDARY EASEMENT BOUNDARY \_\_ \_ \_ \_ \_ \_ **EXISTING FEATURES** CONTOURS STORMWATER PIPE STORMWATER PIT ELECTRICAL CABLE - U/G ----E----E-ELECTRICAL CABLE - O/H EXISTING SEWER PIPE ----S----S-**EXISTING WATER** ---- W---- W-EXISTING WATER (HYDRANT) EXISTING WATER (STOP VALVE) **EXISTING TELECOM COMMUNICATIONS PIT EXISTING GAS** ----G----G-**EXISTING BUILDING** \_\_\_\_\_ TREES / SHRUBS PROPOSED - BUILDING (INDICATIVE ONLY) DWELLING NUMBER UNIT 01 FINISHED FLOOR LEVEL FFL 5.00 **BUILDING FOOTPRINT** 

PROPOSED - UTILITIES SEWER \_\_\_\_s \_\_\_\_s \_\_\_\_ \_\_\_\_ w\_\_\_\_ COMMUNICATIONS \_\_\_\_ T \_\_\_\_ T \_\_\_\_ COMMUNICATIONS - OPTIC FIBRE — OFC—— OFC— **COMMUNICATIONS PIT** GAS —— G ——— G ——— ELECTRICAL CABLE - U/G — E — E — ELECTRICAL CABLE - O/H ---- OHE-----REDUNDANT  $\boldsymbol{A} = \boldsymbol{A} + \boldsymbol{A} +$ PROPOSED - EROSION AND SEDIMENT CONTROL SITE EXCLUSION FENCE -- [X] - [X] - [X] - --SEDIMENT FENCE \_\_\_\_ **DIVERSION DRAIN** STABLISED SITE ACCESS MATERIAL STOCKPILE SLOPE DIRECTION  $\longrightarrow$ GEOTEXTILE INLET FILTER MESH AND GRAVEL INLET FILTER SANDBAG / HAY BALES PROPOSED CONTOURS

PROPOSED - STORMWATER SW PIPE ØXXXmm uPVC X.X% GRADE, X.XXm (INCL. DIA/GRADE/LENGTH) SW PIPE - CHARGED ØXXXmm uPVC CHARGE X.X% GRADE, X.XXm (INCL. DIA/GRADE/LENGTH) SW PIT - GRATED / JUNCTION SW - KERB INLET PIT (INCLUDING LINTEL) RAINWATER/REUSE TANK OR (/////) (⊠) GPT GROSS POLLUTANT TRAP **GRATED DRAIN** INFILTRATION TRENCH **HEADWALL** SUBSOIL <del>--->--->---</del> SW SWALE PIPE RISER  $\circ$  XX PIPE DROPPER  $\mathsf{XX}$ OVERLAND FLOW PATH SW PIT NUMBER SW CATCHMENT XX (X.XXX) (NUMBER / AREA IN ha)


PROPOSED - CIVIL CONCRETE ASPHALTIC CONCRETE SAND **EARTH** RIP RAP BUILDING / STRUCTURES TIMBER **BLOCK PAVERS RETAINING WALL** KERB RAMP VEHICULAR CROSSING **FENCE** BATTER BOLLARD - TYPE 1 (FIXED) B-T1 BOLLARD - TYPE 2 (REMOVABLE) B-T2 LINEMARKING - CHEVRON **EXPANSION JOINT** TRAVERSE JOINT ---- TJ ----**CONTROL JOINT** -----CJ-----FINISHED GRADE LEVELS 25.758 EXISTING GRADE LEVELS 25.710~

ID INSIDE DIAMETER AutoCAD Civil 3D 2021 NFRASTRUCTURE DESIGN PTY LTD. THIS DRAWING MUST NOT BE REPRODUCED IN ANY ORM WITHOUT THE CONSENT OF WALLACE
NFRASTRUCTURE DESIGN PTY LTD. THIS AWING HAS BEEN PRODUCED FOR TI SIGN INTENT AND SCOPE OF WORK QUIRED FOR THE INSTALLATION OF SERVICES DETAILED, AND PERTAINED WITHIN THE CIFICATION AND SHOULD BE READ II CIFICATION, ASSOCIATED SPECIFIC DES AND STANDARDS. ALL DIMENSIONS OMMENCEMENT OF ANY WORKS.

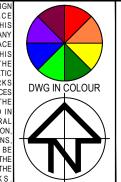

GARAGE FINISHED LEVEL

INSPECTION CHAMBER

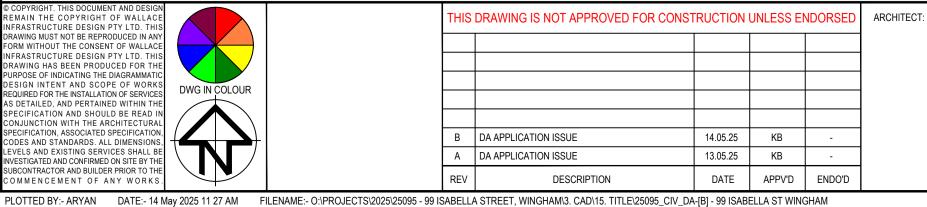

SIDE OUTLET DRAIN

STAINLESS STEEL

STANDARD



D & J CETINIC 37 Patriot Place Rouse Hill NSW 2155



PROJECT: WALLACE INFRASTRUCTURE **DESIGN PTY LTD** PART OF WALLACE DESIGN GROUP PTY LTD WINGHAM NSW 2429

\_\_\_\_\_

MAJOR CONTOUR INTERVAL

MINOR CONTOUR INTERVAL

DRAWING TITLE: CIVIL SERVICES CIVIL WORKS for LEGEND, DRAWING SCHEDULE LOT 01, DP 925163 AND LOCATION PLAN 99 ISABELLA STREET

DA APPROVAL DRAWING STATUS ORIG. SIZE SCALE: N.T.S. Α1 DESIGNED CHECKED APPROVED ENDORSED DATE DRAWN 14.05.25 MS KB ΑK PROJECT No. 25095 C01.01

# **GENERAL NOTES**

- ALL CONSTRUCTION WORKS ARE TO BE CARRIED OUT IN ACCORDANCE WITH COUNCIL'S ENGINEERING REQUIREMENTS FOR DEVELOPMENTS.
- 2. ALL DIMENSIONS, EASEMENTS AND LOTS SUBJECT TO REGISTRATION OF DEPOSITED PLAN.
  3. THESE DRAWINGS ARE TO BE READ IN CONJUNCTION WITH ALL ARCHITECTURAL AND
  CONSULTANT'S DRAWINGS AND SPECIFICATIONS, AND OTHER WRITTEN REPORTS (e.g
  GEOTECHNICAL, ARBORIST, ENVIRONMENTAL, ETC.). ANY DISCREPANCY SHALL BE REFERRED
- TO THE ENGINEER BEFORE PROCEEDING WITH ANY WORKS.

  4. ALL LEVELS SHALL BE OBTAINED FROM ESTABLISHED BENCH MARKS AS DIRECTED BY THE SUPERVISOR.
- 5. THE DEVELOPER, SHALL ENSURE ALL ASSOCIATED DOCUMENTATION (GEOTECHNICAL, LANDSCAPE, ARCHITECTURAL, ELECTRICAL, TELECOM, GAS ETC.) HAS BEEN APPROVED FOR CONSTRUCTION BEFORE COMMENCING ANY WORKS.
- 6. THE CONTRACTOR IS RESPONSIBLE FOR THE LOCATION, PROTECTION AND ADJUSTMENT TO ALL IN GROUND AND ABOVE GROUND SERVICES. SEE HUNTER WATER'S NOTICE OF REQUIREMENTS.
- 7. EROSION CONTROL MEASURES, DEVICES, SILT TRAPS. ETC. ARE TO BE INSTALLED BEFORE ANY SITE DISTURBANCE IN ACCORDANCE WITH COUNCIL INSPECTORS REQUIREMENTS AND SITE SEDIMENTATION AND EROSION CONTROL PLANS.
- 8. IT IS THE CONTRACTORS RESPONSIBILITY TO ENSURE THAT ALL WORKS ARE CARRIED OUT IN ACCORDANCE WITH THE WORK HEALTH SAFETY ACT.
- 9. VEHICULAR ACCESS AND ALL SERVICES ARE TO BE MAINTAINED AT ALL TIMES TO ADJOINING PROPERTIES AFFECTED BY CONSTRUCTION WORKS.
- 10. ALL WASTE OR DEMOLISHED MATERIALS SHALL BE DISPOSED OF OFF SITE TO A COUNCIL
- APPROVED SITE. ALL FEES AND CHARGES SHALL BE INCLUDED IN THE CONTRACT SUM.

  11. CONSTRUCTION VIBRATION TO COMPLY WITH AS2760.1-2004 AND/OR NSW DEPT OF
- ENVIRONMENT AND CONSERVATION NOISE REQUIREMENTS
- 12. EMISSIONS FROM SITE ARE NOT TO INTERFERE WITH THE AMENITY OF THE NEIGHBORHOOD.
- 13. NOISE EMISSIONS ARE TO COMPLY WITH NSW EPA NOISE CONTROL MANUAL. TIME RESTRICTIONS APPLY TO CONSTRUCTION WORKS AS FOLLOWS: 7AM TO 6PM MON-FRI; 8AM TO 1PM SAT.
- 14. TREES & SHRUBS WHICH ARE FELLED SHALL BE SALVAGED FOR RE-USE, EITHER IN LOG FORM, OR AS A WOODCHIP MULCH FOR EROSION CONTROL AND/OR SITE REHABILITATION.

  NON-SALVAGEABLE MATERIAL SUCH AS ROOTS & STUMPS SHALL BE DISPOSED OF IN AN APPROVED MANNER.
- 15. 'ESCP' REFERS TO EROSION AND SEDIMENT CONTROL PLAN, 'SWMP' REFERS TO SOIL AND WATER MANAGEMENT PLAN, AND, 'ESC' REFERS TO EROSION AND SEDIMENT CONTROL.
- 16. SEDIMENT, INCLUDES, BUT IS NOT LIMITED TO, CLAY, SILT, SAND, GRAVEL, SOIL, MUD, CEMENT AND CERAMIC WASTE.
- 17. ANY REFERENCE TO THE BLUE BOOK REFERS TO "MANAGING URBAN STORMWATER SOILS AND CONSTRUCTION", LANDCOM, 2004.
- 18. ANY REFERENCE TO THE IECA WHITE BOOKS (2008) REFERS TO IECA 2008, "BEST PRACTICE EROSION AND SEDIMENT CONTROL". BOOKS 1-6. INTERNATIONAL EROSION CONTROL ASSOCIATION (AUSTRALASIA), PICTON, NSW.
- 19. ANY MATERIAL DEPOSITED IN ANY CONSERVATION AREA FROM WORKS ASSOCIATED WITH THE DEVELOPMENT SHALL BE REMOVED IMMEDIATELY BY MEASURES INVOLVING MINIMAL GROUND AND/OR VEGETATION DISTURBANCES AND NO MACHINERY, OR FOLLOWING DIRECTIONS BY COUNCIL AND/OR WITHIN A TIMEFRAME ADVISED BY COUNCIL.

# SURVEY NOTES

REGISTERED SURVEYOR.

- 1. THE EXISTING SURVEY CONDITIONS SHOWN ON THESE DRAWINGS HAVE BEEN DERIVED FROM SURVEY INFORMATION SUPPLIED BY CALCO SURVEYORS PTY LTD, DATED 12.02.2025, REF NO. 4653 DWG No. 001
- 2. THE INFORMATION SHOWN IS PROVIDED AS A BASIS FOR THE DESIGN. WALLACE DESIGN GROUP DOES NOT GUARANTEE THE ACCURACY OR COMPLETENESS OF THE SURVEY BASE OR ITS SUITABILITY AS A BASIS FOR CONSTRUCTION DRAWINGS.
- 3. SHOULD DISCREPANCIES BE ENCOUNTERED DURING CONSTRUCTION BETWEEN THE SURVEY DATA AND ACTUAL FIELD DATA, CONTRACTOR SHALL CONTACT CALCO SURVEYORS PTY LTD AND OR WALLACE DESIGN GROUP FOR CLARIFICATION.

THE CONTRACTOR SHALL ARRANGE ALL SURVEY SETOUT TO BE CARRIED OUT BY A

# STORMWATER NOTES

- 1. THESE DRAWINGS ARE TO BE READ IN CONJUNCTION WITH RELEVANT ARCHITECTURAL DETAILS.
- 2. ALL WORKS ARE TO BE IN ACCORDANCE WITH AS3500, COUNCIL'S DEVELOPMENT CONTROL PLAN AND PROPRIETARY MANUFACTURERS RECOMMENDATIONS.
- 3. UNLESS OTHERWISE STATED, ALL STORMWATER PIPES (INCLUDING DOWNPIPES AND RAINWATER TANK OVERFLOW PIPES) ARE TO BE uPVC SEWER GRADE, U.N.O JOINTED & INSTALLED TO MANUFACTURERS RECOMMENDATIONS.
- 4. ALL uPVC STORMWATER LINES TO HAVE ALL JOINTS, INC. DOWNPIPE CONNECTIONS, FULLY
- SOLVENT WELDED, INCLUDING ANY CHARGED LINES.

  CONNECT DOWNPIPES AS REQUIRED TO NOMINATED HARVESTING TANK IN ACCORDANCE WITH
- APPROVED DEVELOPMENT PLANS AND HYDRAULIC ENGINEERS DESIGN.

  6. ALL LEVELS ARE DATUM AHD.
- 7. ALL LEVELS ARE FINISHED PAVEMENT OR LAWN LEVELS.
- CONTRACTOR TO ALLOW FOR ALL PIPE SUPPORT SYSTEM TO SOFFIT AS PER MANUFACTURERS SPECIFICATIONS.
- 9. ALL CONCRETE TO BE MANUFACTURED AND SUPPLIED IN ACCORDANCE WITH AS1379.
- 10. AT COUNCILS DISCRETION, ALL CONCRETE CAN BE SUBJECT TO PROJECT ASSESSMENT AND TESTING TO AS1379
- 11. MINIMUM PIPE COVERS TO BE IN ACCORDANCE WITH AS3500.
- 12. PITS TO BE FILLED ACCORDINGLY TO MEET INVERTS AS NEEDED.
- CONTRACTOR TO CONFIRM ALL LEVELS PRIOR TO CONSTRUCTION. ANY DISCREPANCIES ARE TO BE IMMEDIATELY REPORTED TO WALLACE DESIGN GROUP.

# SUBSOIL DRAINAGE NOTES

- I. CONSTRUCTION SHALL BE IN ACCORDANCE WITH COUNCIL'S CONSTRUCTION SPECIFICATIONS FOR SUBSURFACE DRAINAGE.
- 2. SUBSOIL PIPE TO BE Ø100 SLOTTED PVC OR CORRUGATED CIRCULAR PLASTIC PIPE AND ENCLOSED IN SEAMLESS FILTER FABRIC SOCK
- SUBSOIL DRAINS SHALL CONSIST OF A 300 (MINIMUM) WIDE TRENCH, BACKFILLED WITH 7 OR 10mm AGGREGATE AND WRAPPED IN BIDIM A12 GEOTEXTILE FABRIC OR SIMILAR, LAPPED AT THE TOP. DEPTH OF TRENCH TO EXTEND 450 (MINIMUM) IN ROCK OR 600 (MINIMUM) IN EARTH BELOW FINISHED SUB-GRADE LEVEL. INVERT OF TRENCH SHOULD ALSO BE LOWER THAN THE INVERT OF ANY SERVICE CROSSINGS.




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OMMENCEMENT OF ANY WORKS

DWG IN COLOUR



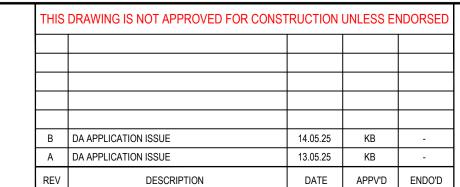

D & J CETINIC

37 Patriot Place

Rouse Hill NSW 2155



PROJECT:
CIVIL WORKS for
LOT 01, DP 925163
99 ISABELLA STREET
WINGHAM NSW 2429

CIVIL SERVICES
GENERAL NOTES

 DA APPROVAL NOT TO BE USED FOR CONSTRUCTION


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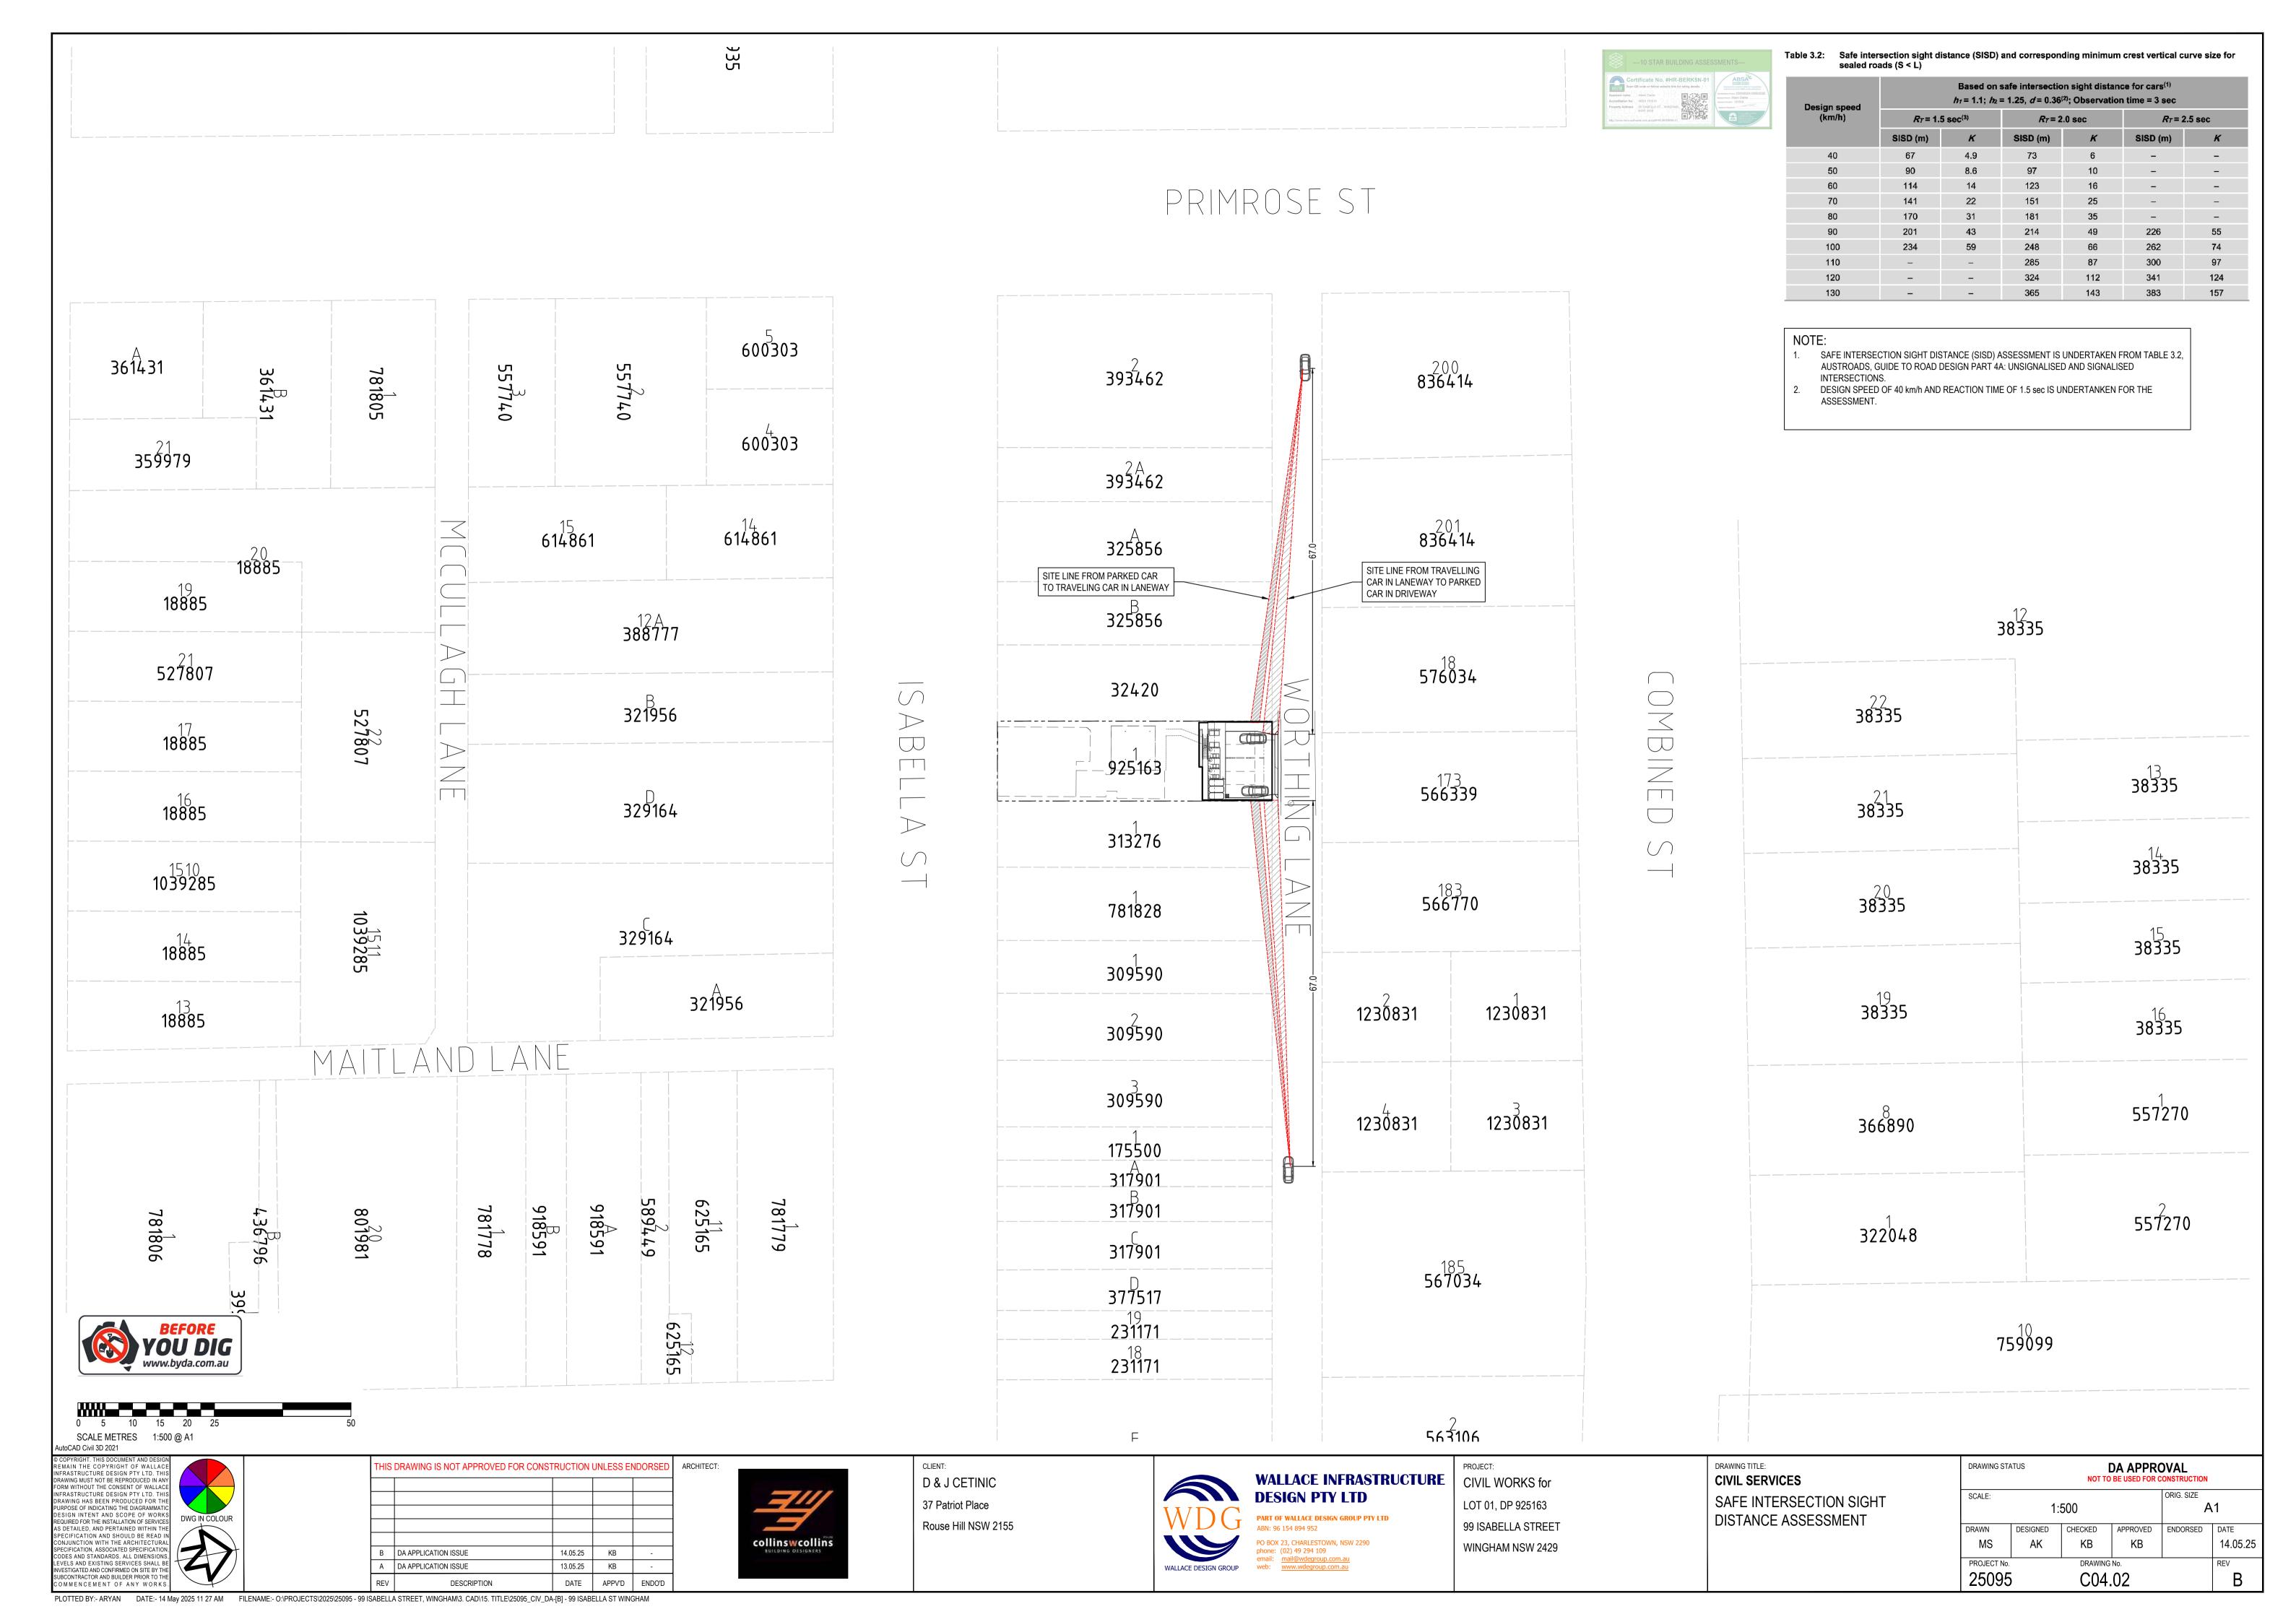
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 DESIGNED
 CHECKED
 APPROVED
 ENDORSED
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 14.05.25

 PROJECT No.
 DRAWING No.
 REV

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 C02.01
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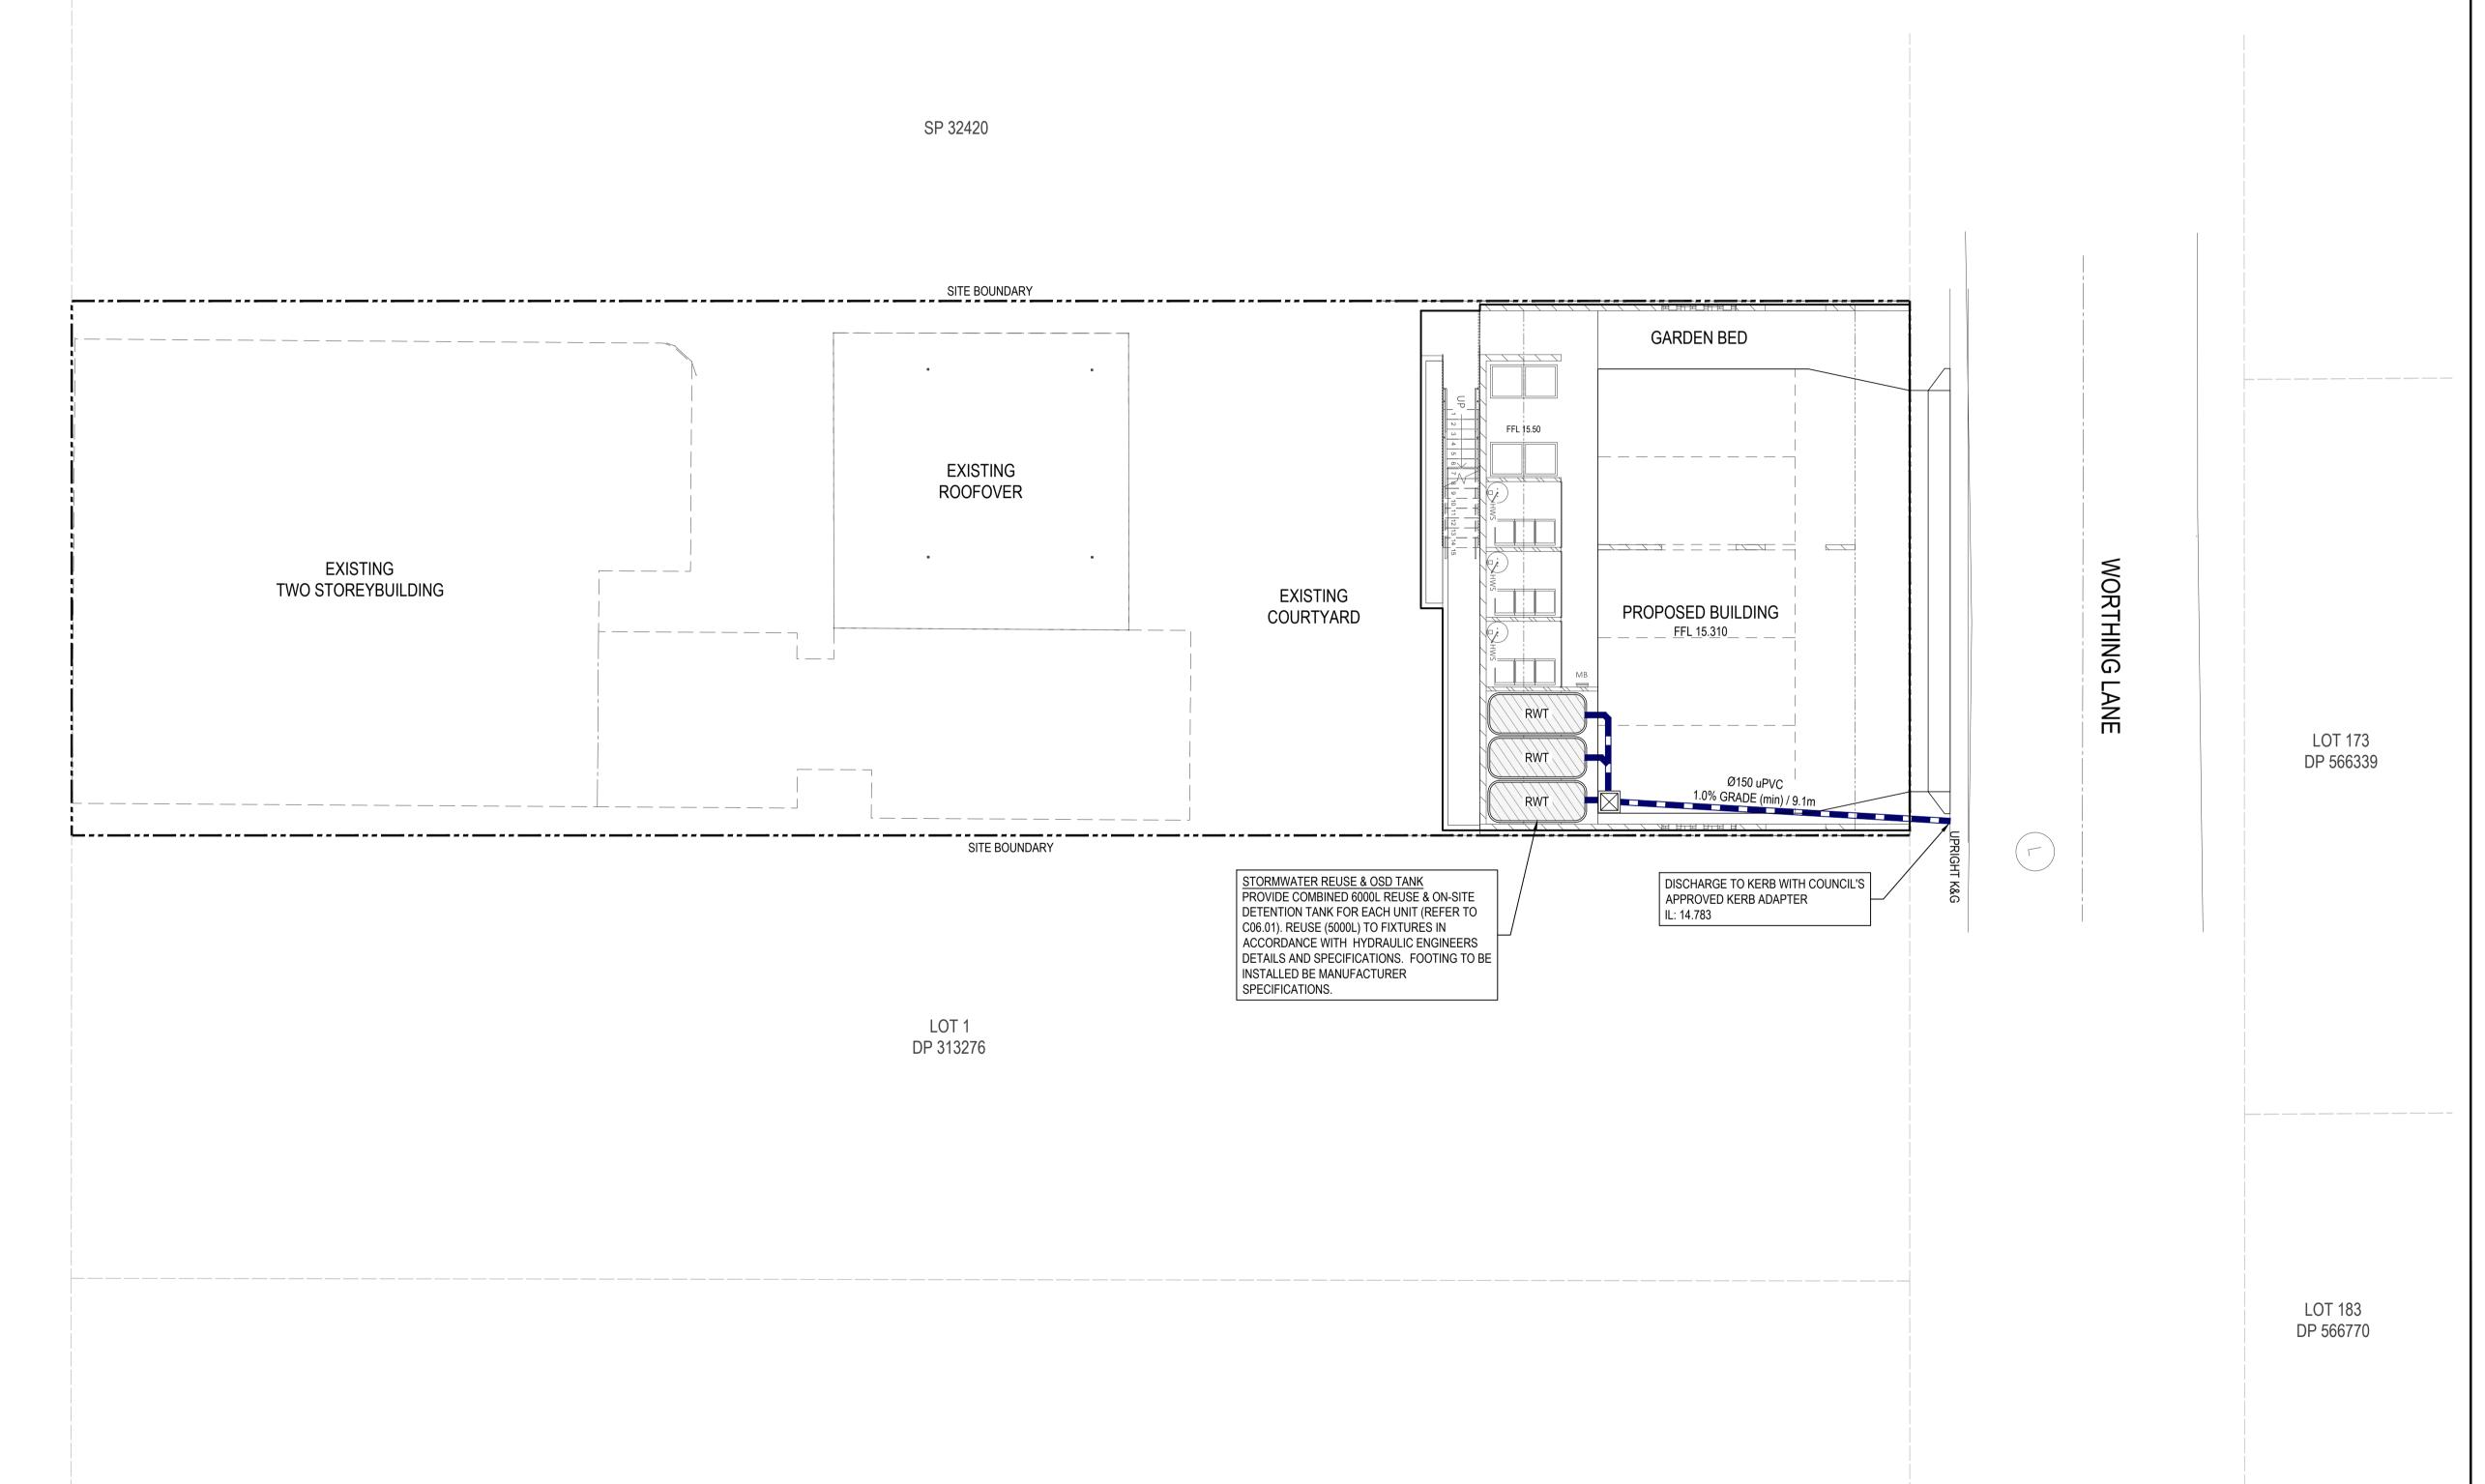


STORMWATER DETENTION RESULTS				
DESCRIPTION / STORM EVENT	20% AEP	5% AEP	1% AEP	
PRE-DEVELOPED PEAK FLOW (L/s)	25	39	59	
DEVELOPED PEAK FLOW (L/s) w/DETENTION	23	35	50	

#### NO

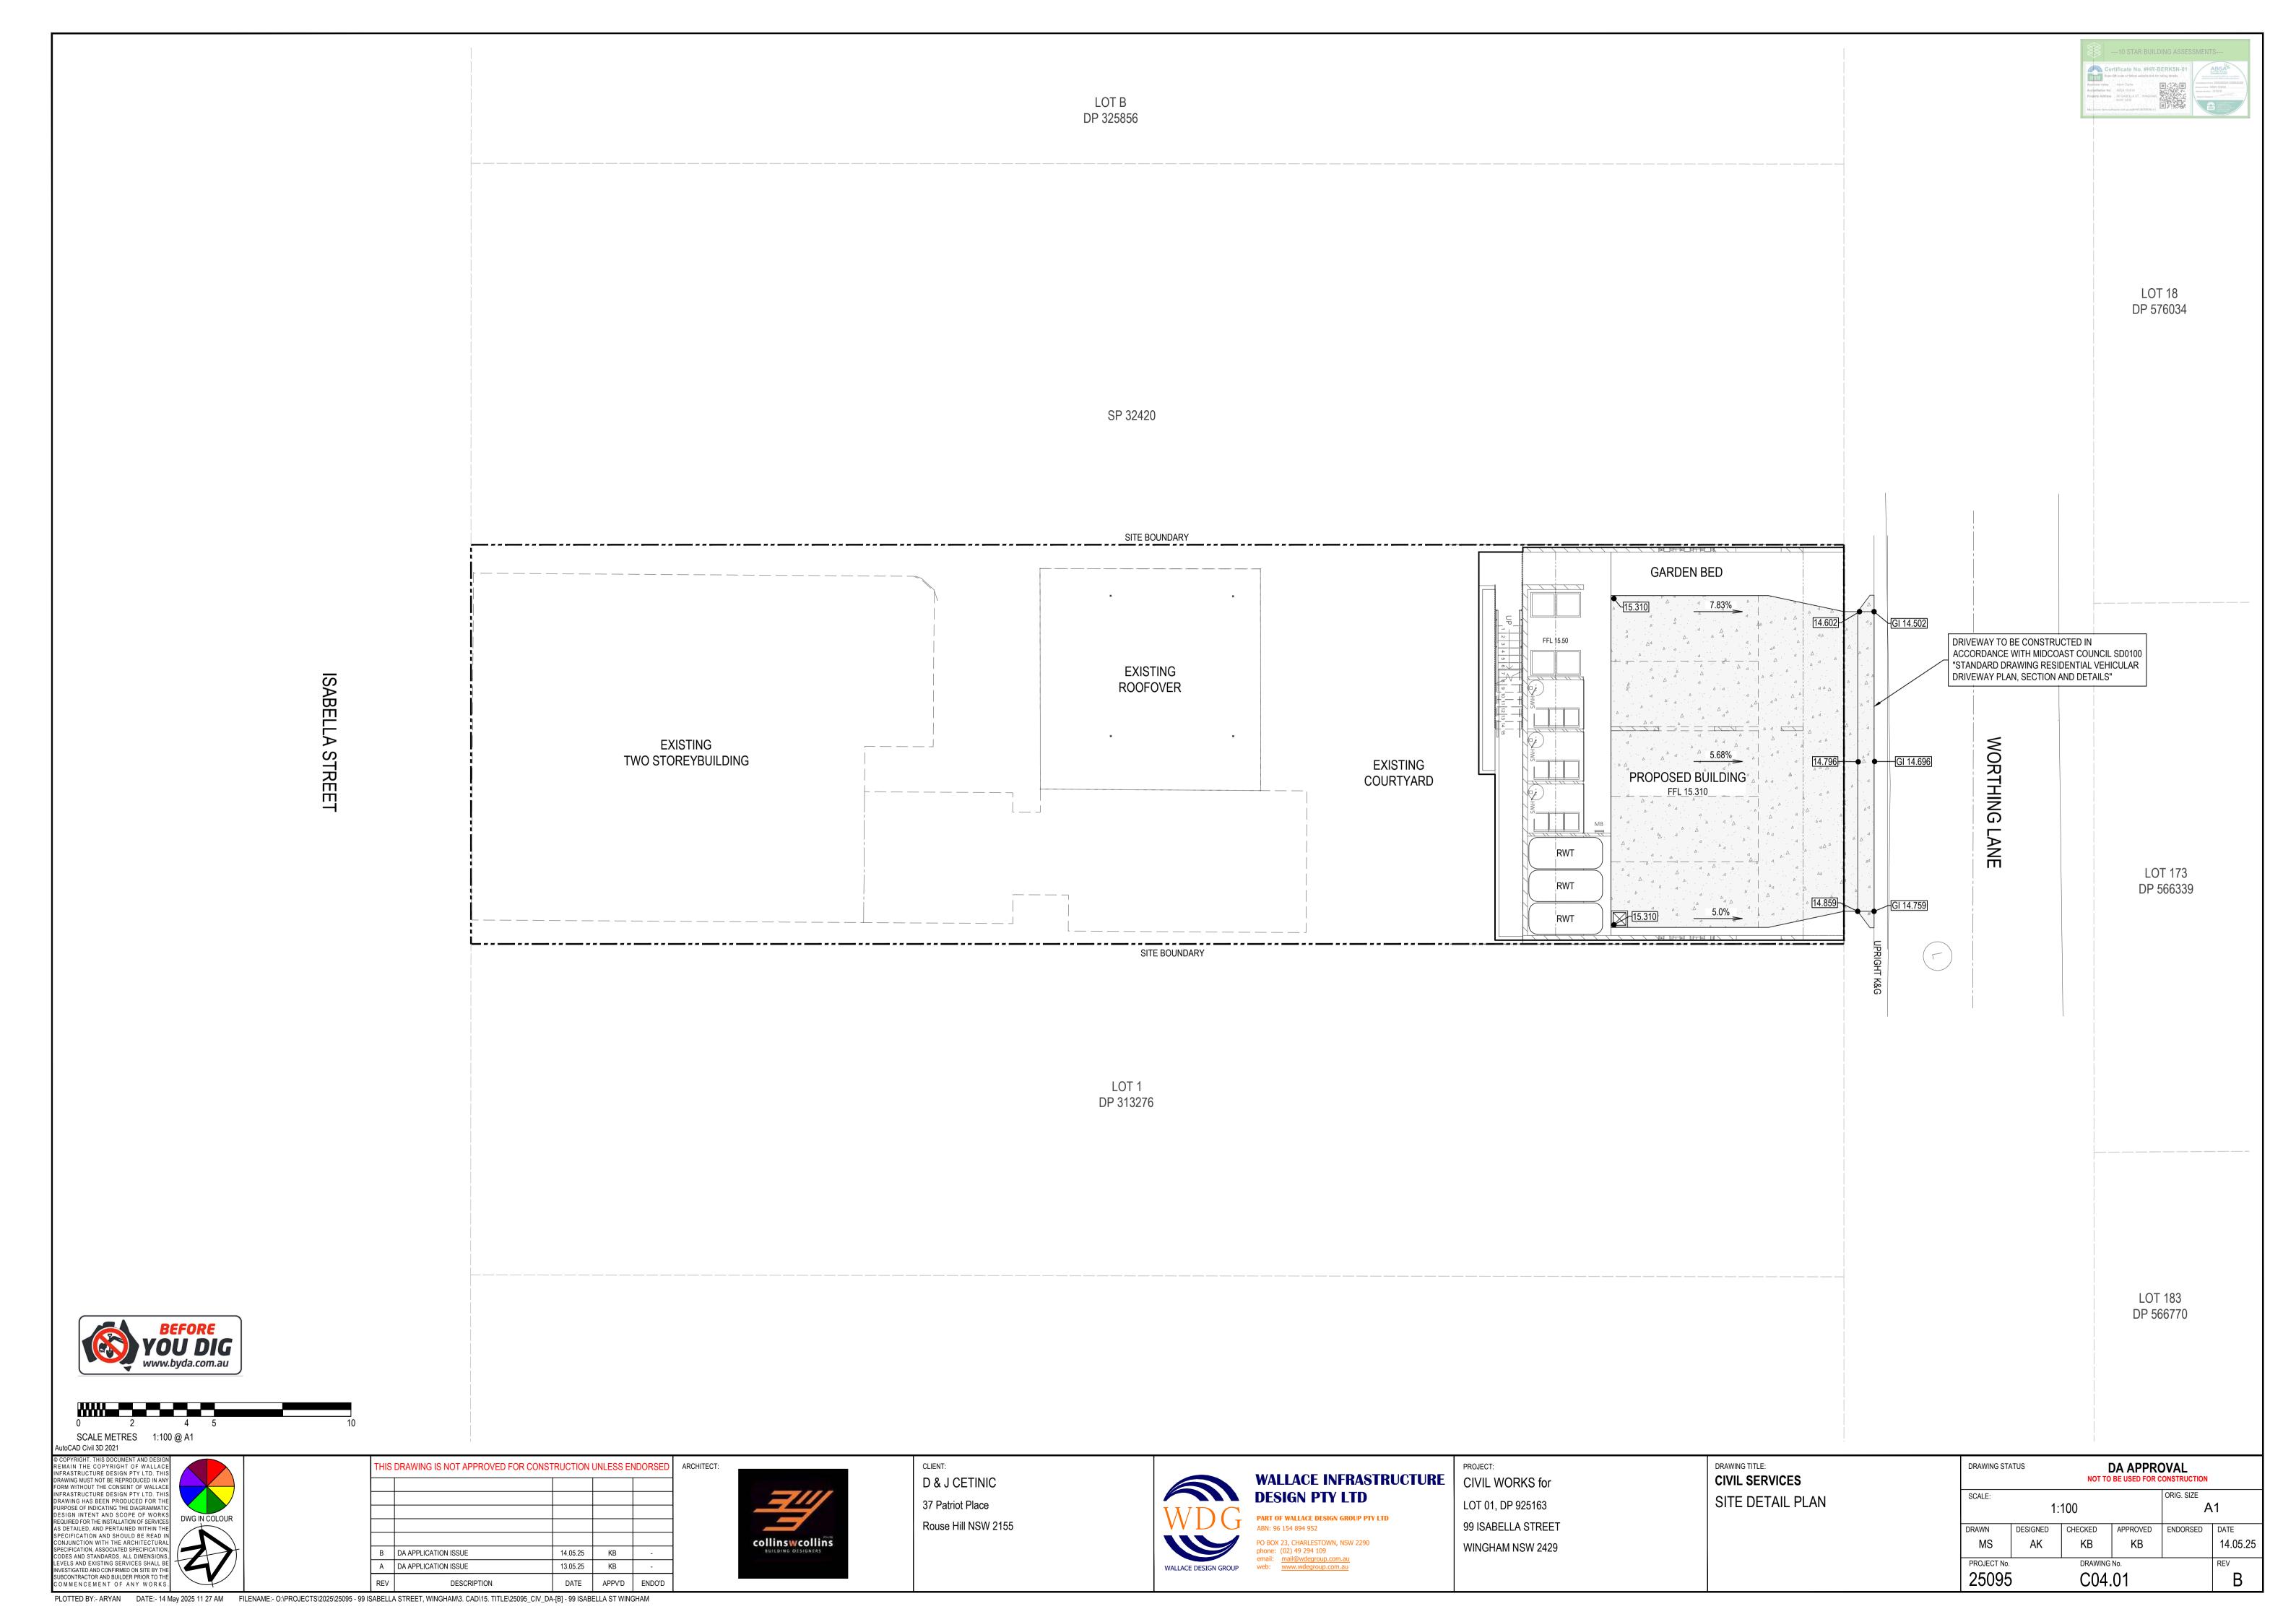- STORMWATER ANALYSIS HAS BEEN COMPLETED USING DRAINS MODELLING SOFTWARE IN ACCORDANCE WITH BOOK 9, RUNOFF IN URBAN AREAS, AUSTRALIA RAINFALL AND RUNOFF, A

  OURSE TO FLOOD ESTIMATING 2010.
  - GUIDE TO FLOOD ESTIMATING, 2019.
    2. ASSUMPTIONS FOR STORMWATER ANALYSIS INCLUDE:
    - BASIX REQUIREMENT EXCLUDED FROM ANALYSIS.RAINWATER REUSE VOLUMES EXCLUDED FROM PRELIMINARY ANALYSIS.





0 2 4 5

SCALE METRES 1:100 @ A1

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PLOTTED BY:- ARYAN DATE:- 14 May 2025 11 27 AM FILENAME:- O:\PROJECTS\2025\25095 - 99 ISABELLA STREET, WINGHAM\3. CAD\15. TITLE\25095\_CIV\_DA-[B] - 99 ISABELLA ST WINGHAM

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CONJUNCTION WITH THE ARCHITECTURAL	<b>3</b>


THIS	HIS DRAWING IS NOT APPROVED FOR CONSTRUCTION UNLESS ENDORSED				
	DA ADDI ICATION ICCUE	14.05.05	I/D		
В	DA APPLICATION ISSUE	14.05.25	KB	-	
Α	DA APPLICATION ISSUE	13.05.25	KB	-	
REV	DESCRIPTION	DATE	APPV'D	ENDO'D	



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Rouse Hill NSW 2155



PROJECT:	-
CIVIL WORKS for	
LOT 01, DP 925163	
99 ISABELLA STREET	
WINGHAM NSW 2429	

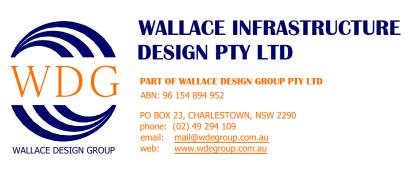
DRAWING TITLE:  CIVIL SERVICES
STORMWATER MANAGEMENT PLAN

	DRAWING STATUS  DA APPROVAL  NOT TO BE USED FOR CONSTRUCTION					
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		1:	100		A1	
	DRAWN	DESIGNED	CHECKED	APPROVED	ENDORSED	DATE
	MS	AK	KB	KB		14.05.25
	PROJECT No.		DRAWING	No.	•	REV
25095		C05.	01		В	

# GENERAL RAINWATER TANK NOTES:

- ALL UNITS ARE TO BE CONNECTED TO THE SPECIFIED RAINWATER REUSE/STORAGE TANK AS NOTED ON THE STORMWATER DRAINAGE PLAN SHEET.
- DAVEY RAINBANK MAINS SWITCHOVER (OR EQUIVALENT) AND RAINWATER TANK TO BE INSTALLED PER MANUFACTURERS SPECIFICATIONS.
- VOLUMES SHOWN FOR REUSE AND DETENTION ARE PROVIDED TO COMPLY WITH BASIX AND/OR COUNCIL GUIDELINES AND DO NOT INCLUDE THE PERMANENT VOLUME REQUIRED FOR OPERATION OF THE PUMP.



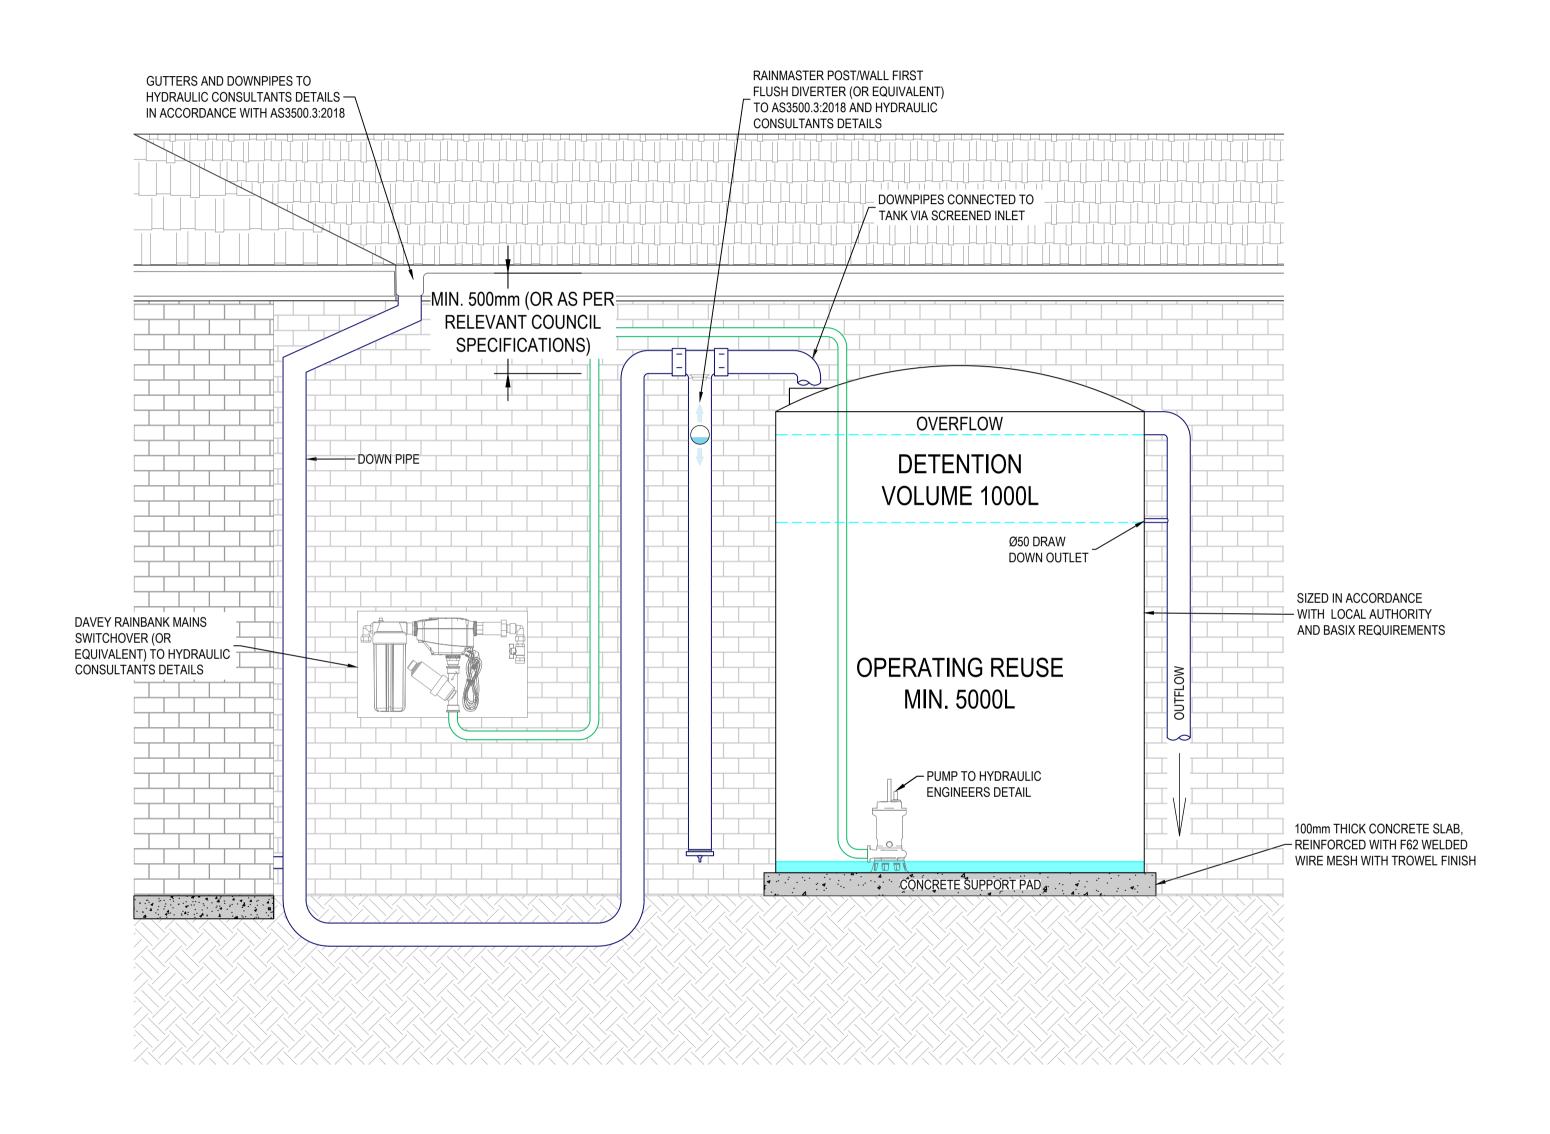


TYPICAL ABOVEGROUND RAINWATER REUSE TANK SECTION



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DWG IN COLOUR



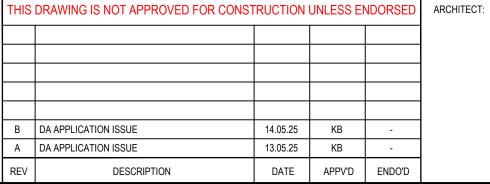

D & J CETINIC 37 Patriot Place Rouse Hill NSW 2155





LOT 01, DP 925163 99 ISABELLA STREET WINGHAM NSW 2429

DRAWING TITLE: **CIVIL SERVICES** RAINWATER TANK TYPICAL SECTION & DETAILS

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NS	SCALE:	N.7	N.T.S.			1
	DRAWN	DESIGNED	CHECKED	APPROVED	ENDORSED	DATE
	MS	AK	KB	KB		14.05.25
	PROJECT No.		DRAWING No. REV			
	25095	)	C06.01			



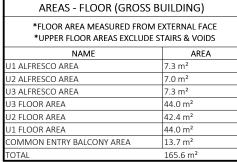

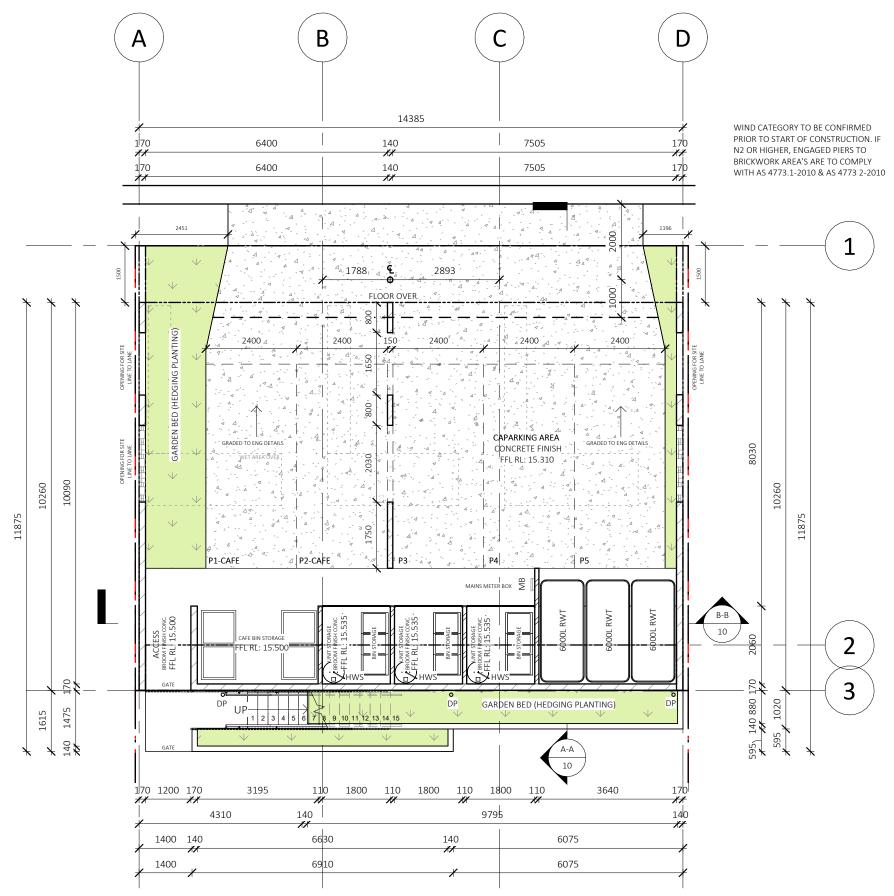



BAL - N/A

**BUSHFIRE NOTES:** NOT APPLICABLE

#### **BASIX/NATHERS NOTES:**

#### PLEASE REFER TO THE "SUMMARY OF BASIX COMMITMENTS" ON PAGE 2 FOR FURTHER INFORMATION. PLEASE REFER TO THE BASIX CERTIFICATE FOR EXACT DETAILS

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oe ans,	PROJECT:	
or	STATUS: DA	ISSUE DRAFT
is to	LOT No: 1	<b>DP No:</b> 9251
15 10	STREET: 99	ISABELLA ST, WII
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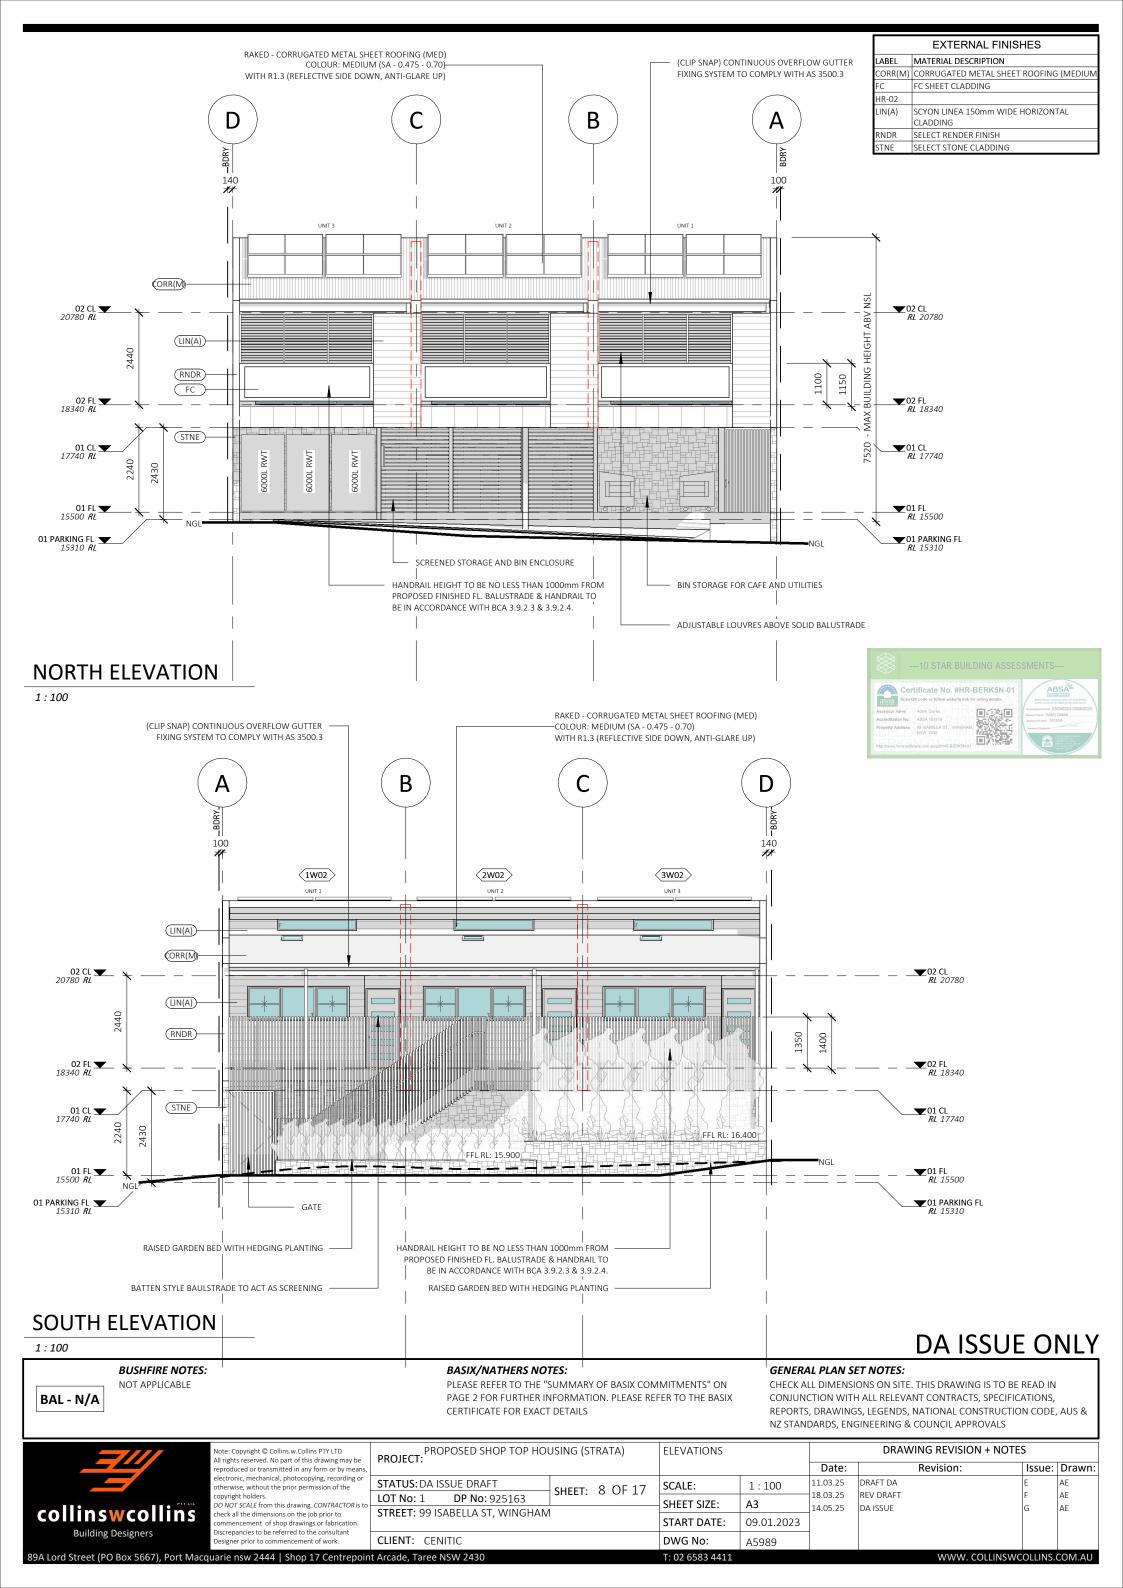
PROJECT: PROPOSED SHOP TOP HOU	JSING (ST	TRATA)
STATUS: DA ISSUE DRAFT	SHEET: 6 OF 1	
LOT No: 1 DP No: 925163	SHEET:	0 OF 17
STREET: 99 ISABELLA ST, WINGHAM	İ	


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	SHEET SIZE:	A3	18.03.25 14.05.25	REV DA
	START DATE:	09.01.2023		
	DWG No:	A5989		
	T: 02 6583 4411			

LOWER FLOOR PLAN

Revision: Date: Issue: Drawn: AFT DA V DRAFT AE ISSUE AE

DRAWING REVISION + NOTES



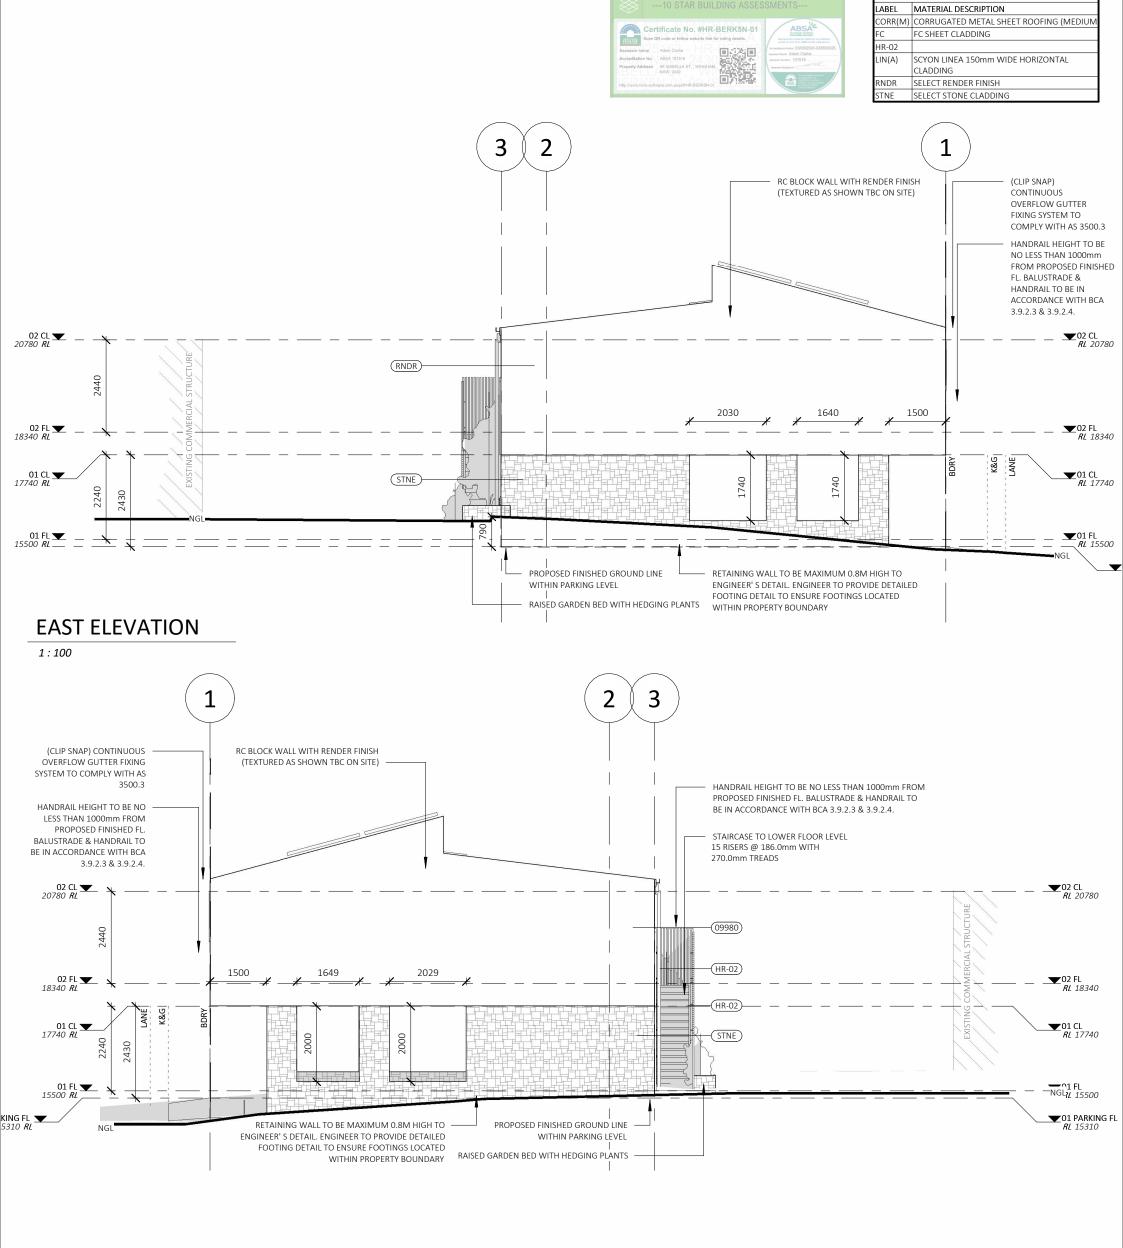

#### **WEST ELEVATION**

1:100

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**EXTERNAL FINISHES** 

BAL - N/A

**BUSHFIRE NOTES:** NOT APPLICABLE

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PROPOSED SHOP TOP HOUSING (STRATA)

**CLIENT:** CENITIC

**STATUS:** DA ISSUE DRAFT **SHEET:** 9 OF 17 LOT No: 1 DP No: 925163 STREET: 99 ISABELLA ST, WINGHAM

SCALE: 1:100 SHEET SIZE: А3 START DATE: 09.01.2023

A5989

**ELEVATIONS** 

DWG No:

T: 02 6583 441


Revision: Date: Issue: Drawn 11.03.25 DRAFT DA 18.03.25 REV DRAFT AE 14.05.25 DA ISSUE AE

DRAWING REVISION + NOTES

89A Lord Street (PO Box 5667), Port Macquarie nsw 2444 | Shop 17 Centrepoint Arcade, Taree NSW 2430

Designer prior to commencement of work.

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1:100

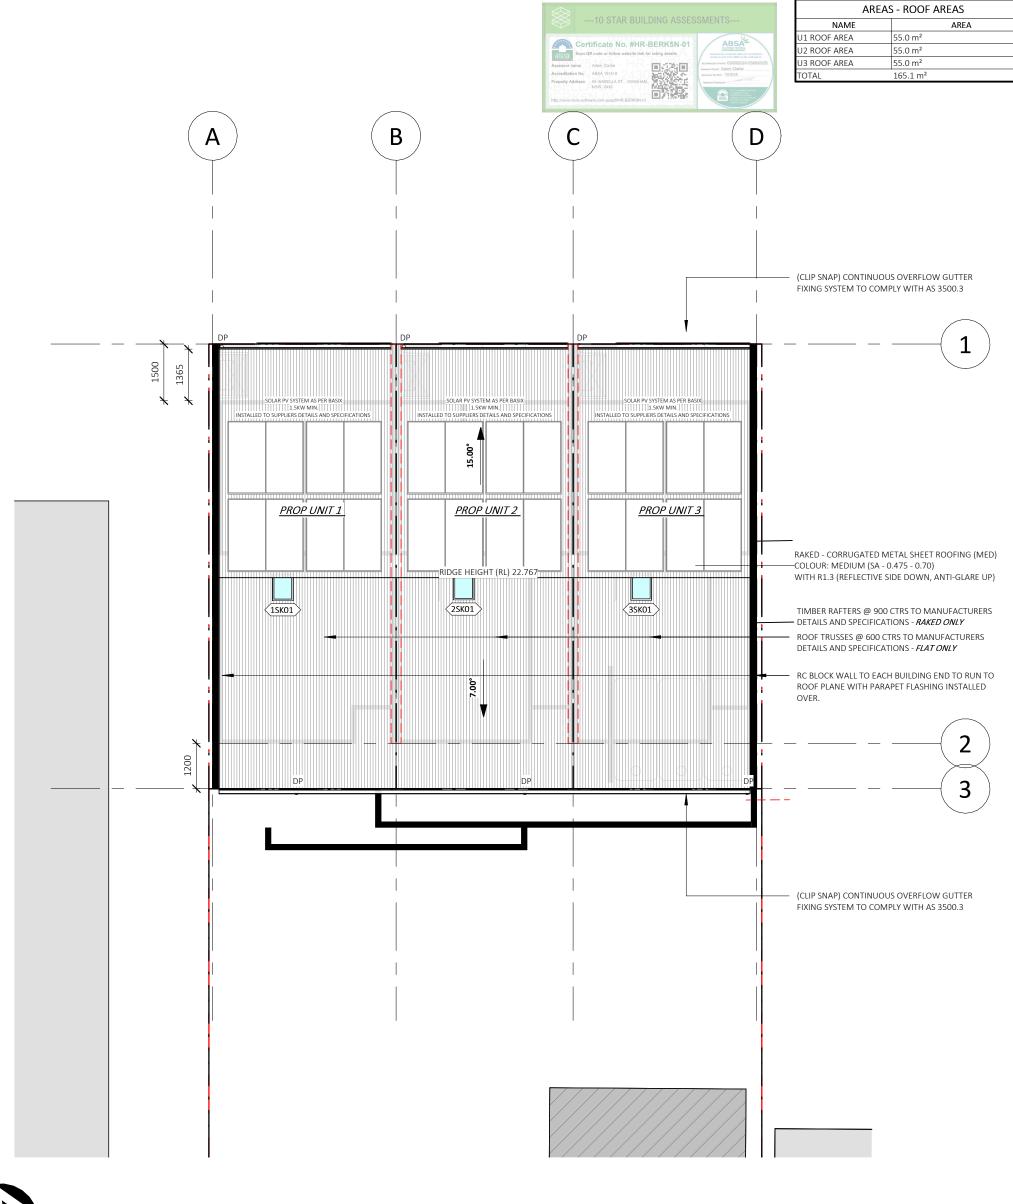BAL - N/A

**BUSHFIRE NOTES:** NOT APPLICABLE

#### **BASIX/NATHERS NOTES:**

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DA ISSUE

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PROJECT: PRO	POSED SHOP TOP HO	USING (STRATA)
STATUS: DA IS	SUE DRAFT	SHEET: 11 OF 17
LOT No: 1	DP No: 925163	SHEET: II OF I7
STREET: 99 ISA	ABELLA ST, WINGHAM	İ

SCALE:	1:100	11.03.25
SHEET SIZE:	A3	18.03.25 14.05.25
START DATE:	09.01.2023	
DWG No:	15080	

**ROOF PLAN** 

DRAWING REVISION + NOTES Revision: Date: Issue: Drawn: DRAFT DA REV DRAFT AE

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#### WINDOW GLAZING SCHEDULE

WINDOWS SPECIFIED USE NFRC UW & SHGCW VALUES. WINDOWS AS SPECIFIED OR EQUIVALENT MUST BE INSTALLED ON SITE

WEATHER STRIPPING TO BE INSTALLED THROUGHOUT.

PLEASE NOTE: ALL GLAZING IN BATHROOMS, ENSUITES, SPA ROOMS OR THE LIKE TO COMPLY WITH THE NCC. VOL 2. H1D8 AND PART 8.4.6 OF ABCB HOUSING PROVISIONS

AS 4055 : WIND LOADS FOR HOUSING AS 1288: GLASS IN BUILDING - SELECTION & INSTALLATION AS 2047: WINDOWS & EXTERNAL DOORS IN BUILDING AS 1170-Part 2: WIND ACTIONS AS 3959: CONSTRUCTION OF BUILDINGS IN BUSHFIRE PRONE AREAS THE STANDARDS REFERRED ABOVE ARE THE VERSION ADOPTED BY BCA AT THE TIME THE RELEVANT CONSTRUCTION CERTIFICATE OR COMPLYING DEVELOPMENT CERTIFICATE APPLICATION IS MADE.

NUMBER	LEVEL	ROOM	HEIGHT	WIDTH	TYPE	CONSTRUCTION	GLAZING	AREA
1W01	02 FL	BED 1	900	2710	DOUBLE HUNG/FIXED	ALUMINIUM	DBL - STD - CLEAR	2.44 m²
					GLASS/DOUBLE HUNG			
1W02	02 CL	CLERESTORY	300	2110	FIXED GLASS	ALUMINIUM	DBL - STD - CLEAR	0.63 m <sup>2</sup>
2W01	02 FL	BED 1	900	2710	DOUBLE HUNG/FIXED	ALUMINIUM	DBL - STD - CLEAR	2.44 m <sup>2</sup>
					GLASS/DOUBLE HUNG			
2W02	02 CL	CLERESTORY	300	2110	FIXED GLASS	ALUMINIUM	DBL - STD - CLEAR	0.63 m <sup>2</sup>
3W01	02 FL	BED 1	900	2710	DOUBLE HUNG/FIXED	ALUMINIUM	DBL - STD - CLEAR	2.44 m²
					GLASS/DOUBLE HUNG			
3W02	02 CL	CLERESTORY	300	2110	FIXED GLASS	ALUMINIUM	DBL - STD - CLEAR	0.63 m <sup>2</sup>

9.22 m<sup>2</sup>

# DOOR GLAZING SCHEDULE

DOORS SPECIFIED USE NFRC UW & SHGCW VALUES. DOORS AS SPECIFIED OR EQUIVALENT MUST BE INSTALLED ON SITE

WEATHER STRIPPING TO BE INSTALLED THROUGHOUT.

PLEASE NOTE: ALL GLAZING IN BATHROOMS, ENSUITES, SPA ROOMS OR THE LIKE TO COMPLY WITH THE NCC. VOL. 2. H1D8 AND PART 8.4.6 OF ABCB HOUSING PROVISIONS

AS 4055 : WIND LOADS FOR HOUSING AS 1288 : GLASS IN BUILDING - SELECTION & INSTALLATION AS 2047: WINDOWS & EXTERNAL DOORS IN BUILDING AS 1170-Part 2: WIND ACTIONS THE STANDARDS REFERRED ABOVE ARE THE VERSION ADOPTED

AS 3959 : CONSTRUCTION OF BUILDINGS IN BUSHFIRE PRONE AREAS BY BCA AT THE TIME THE RELEVANT CONSTRUCTION CERTIFICATE OR COMPLYING DEVELOPMENT CERTIFICATE APPLICATION IS MADE.

NUMBER	LEVEL	ROOM	HEIGHT	WIDTH	TYPE	CONSTRUCTION	GLAZING	AREA
1GD01	02 FL	MEALS/LIVING	2100	3210	STACKING 3P	ALUMINIUM	DBL - STD - CLEAR	6.74 m²
2GD01	02 FL	MEALS/LIVING	2100	3210	STACKING 3P	ALUMINIUM	DBL - STD - CLEAR	6.74 m <sup>2</sup>
3GD01	02 FL	MEALS/LIVING	2100	3210	STACKING 3P	ALUMINIUM	DBL - STD - CLEAR	6.74 m <sup>2</sup>

# DA ISSUE ONLY

**BUSHFIRE NOTES:** 

NOT APPLICABLE

#### **BASIX/NATHERS NOTES:**

PLEASE REFER TO THE "SUMMARY OF BASIX COMMITMENTS" ON PAGE 2 FOR FURTHER INFORMATION, PLEASE REFER TO THE BASIX CERTIFICATE FOR EXACT DETAILS

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GLAZING SCALE: SHEET SIZE: START DATE:

Date: 11.03.25 18.03.25 Α3 14.05.25 09.01.2023

A5989

DRAWING REVISION + NOTES Revision: Issue: Drawn: DRAFT DA

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DA ISSUE


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DWG No: T: 02 6583 4413


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# LANDSCAPE PLAN

1:200

#### 15

# ISABELLA STREET
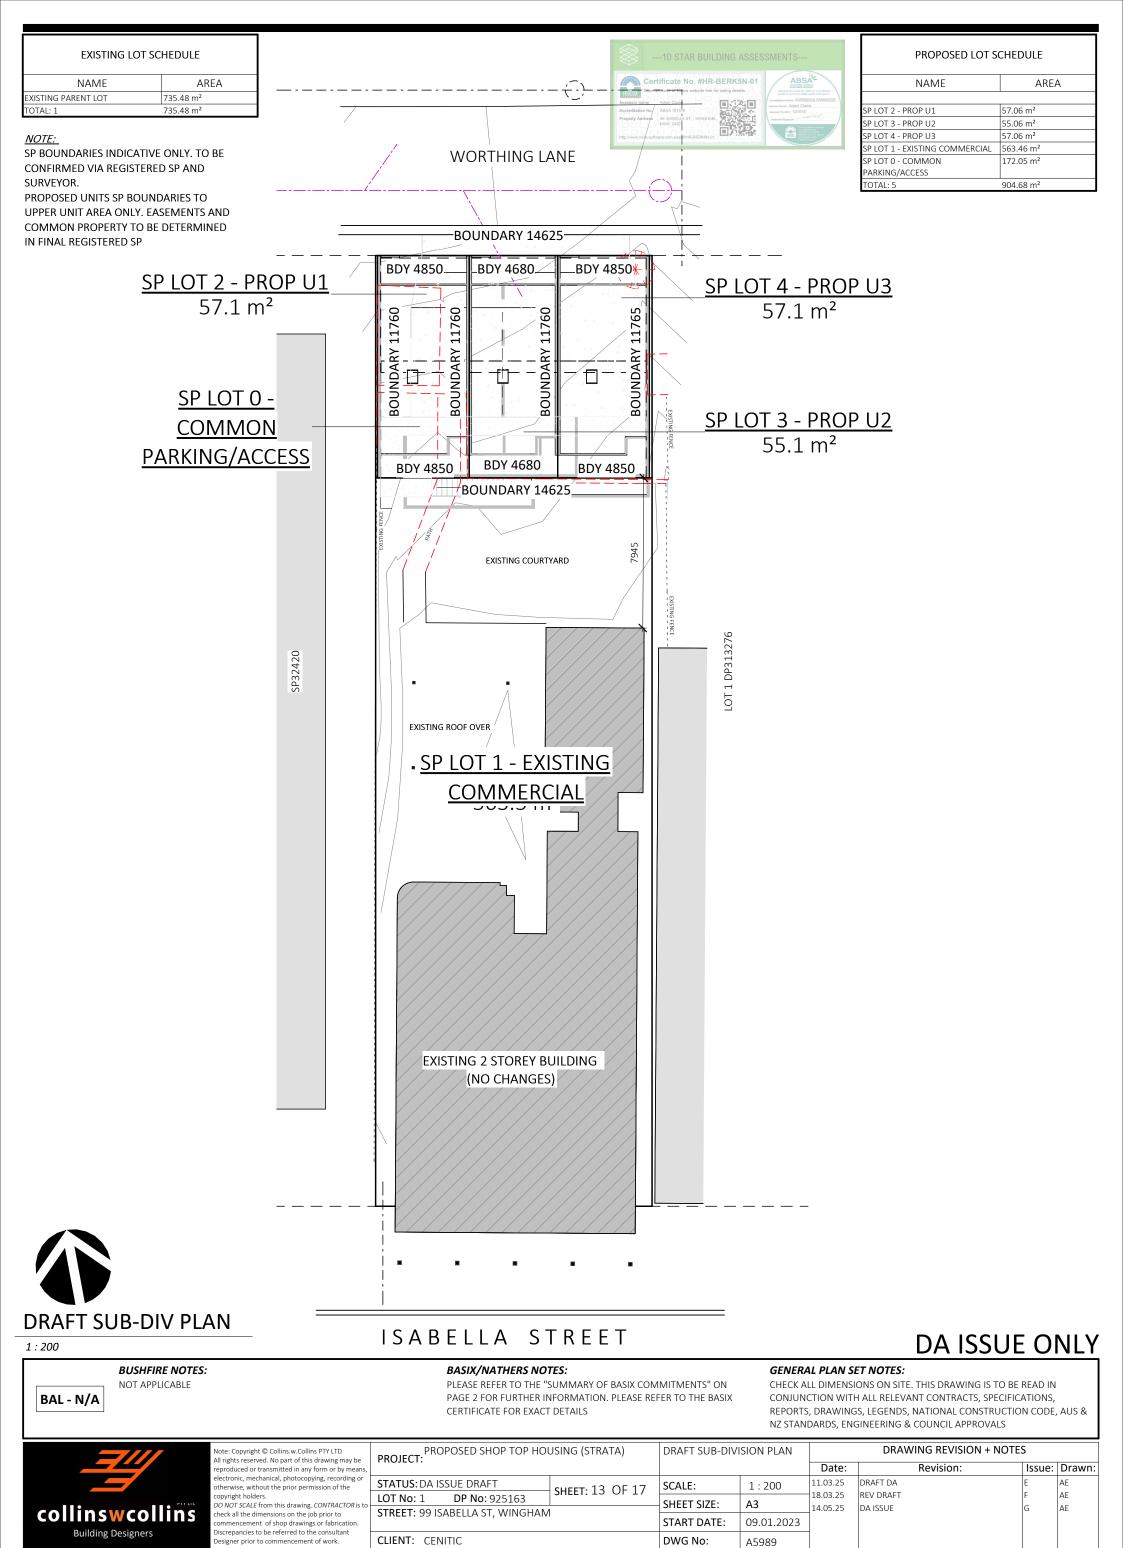
#### LANDSCAPE LEGEND AND NOTES

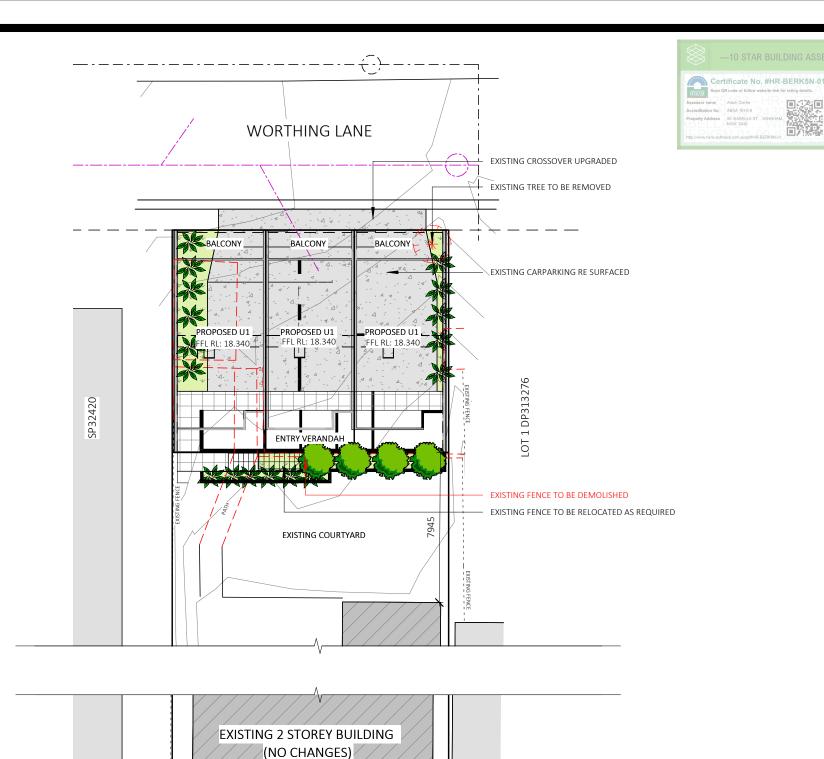

NEW WARM SEASON TURF GRASS THROUGHOUT



UNSEALED SURFACE - GRAVEL FINISH (NOT HARDSTAND AREA)



HARD SURFACE - DRIVEWAY/ PATHWAYS REFER BUILDING DESIGN FOR DETAILS



HARD SURFACE - PATIOS REFER BUILDING DESIGN FOR DETAILS



EXISTING STREET TREE



EXISTING VEGETATION TO BE REMOVED



EXISTING VEGETATION TO BE PRESERVED AND PROTECTED THROUGHOUT



SMALL EVERGREEN NATIVE TREES FEATURE OR STATEMENT PLANTINGS



NEW SMALL / MEDIUM EVERGREEN SHRUBS



NEW SMALL / MEDIUM EVERGREEN SOFT WOODED PERENNIALS



NEW EVERGREEN PROSTRATE SHRUBS OR GROUND COVER PLANTINGS

## GENERAL NOTES:

- THIS PLAN IS NOT BE USED FOR CONSTRUCTION
- THIS PLAN IS CONCEPTUAL ONLY AND IS DESIGNED TO HIGHLIGHT VARIOUS LANDSCAPE
  USES AROUND THE SITE
- ANY SUGGESTED PLANTS OR PLANT LIST IS INDICATIVE ONLY AND THE FINAL SELECTION
  OF ACTUAL SPECIES WILL BE SITE AND MICRO CLIMATE DEPENDENT
- ALL HARD-SCAPED SURFACES SHALL BE INSTALLED BY QUALIFIED LANDSCAPE TRADES
   AND AS PER MANUFACTURERS INSTRUCTIONS
   TURF SPECIES SHALL CONSISTS OF A WARM SEASON SPECIES ONLY SUCH AS; BUFFALO,
- KIKUYU OR COUCH
   THE ADVICE AND PLAN FROM A PROFESSIONAL LANDSCAPE DESIGNER IS TO BE SOUGHT PRIOR TO ANY CONSTRUCTION / LANDSCAPE WORKS COMMENCING
- LANDSCAPE HAS A DOMINANT NORTHERN ASPECT AND SELECTED PLANTS ARE TO BE SUN
  TO FULL SUN TOLERANT CAPABLE OF WITHSTANDING YEAR ROUND NORTHERN SUN
- PLANTS ON THE IMMEDIATE SOUTHERN SIDE OF BUILDINGS AND DWELLING MAY NEED SOME SHADE TOLERANCE
- PLANTINGS ARE TO BE WATER WISE AND DROUGHT TOLERANT ONCE ESTABLISHED

# DA ISSUE ONLY

#### BUSHFIRE NOTES:

BAL - N/A

#### BASIX/NATHERS NOTES:

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PROJECT: PROPOSED SHOP TOP HOU	JSING (STRATA)
STATUS: DA ISSUE DRAFT	SHEET: 14 OF 17
LOT No: 1 DP No: 925163	SHEET: 14 OF 17
STREET: 99 ISABELLA ST, WINGHAM	
CLIENT: CENITIC	

INDICATIVE LANDSCAPE		DRAWING REVISION + NOTES					
	PLAN		Date:	Revision:	Issue:	Drawn:	
	SCALE:	1:200	11.03.25	DRAFT DA	E	AE	
			18.03.25	REV DRAFT	F	AE	
	SHEET SIZE:	A3	14.05.25	DA ISSUE	G	AE	
	START DATE:	09.01.2023					
	DWG No:	Λ5080					

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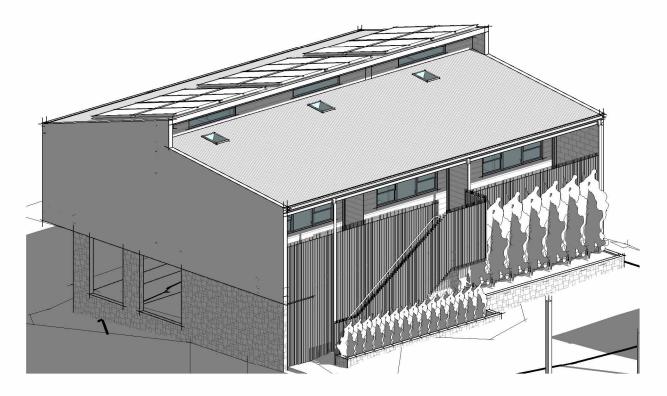


AREAS - FLOOR (GROSS BUILDING)			
*FLOOR AREA MEASURED FROM E *UPPER FLOOR AREAS EXCLUDE S	–		
NAME	AREA		
J1 ALFRESCO AREA	7.3 m <sup>2</sup>		
J2 ALFRESCO AREA	7.0 m <sup>2</sup>		
J3 ALFRESCO AREA	7.3 m <sup>2</sup>		
J3 FLOOR AREA	44.0 m <sup>2</sup>		
J2 FLOOR AREA	42.4 m²		
J1 FLOOR AREA	44.0 m <sup>2</sup>		
OMMON ENTRY BALCONY AREA	13.7 m²		
OTAL	165.6 m <sup>2</sup>		

**CONCEPTUAL PERSPECTIVE 1** 



# **CONCEPTUAL PERSPECTIVE 2**



# **CONCEPTUAL PERSPECTIVE 3**

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BAL - N/A

**BUSHFIRE NOTES:** NOT APPLICABLE

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PROJECT: PROPOSED SHOP TOP HOUSING (STRATA)				
STATUS: DA ISSUE DRAFT		SHEET: 15 OF 17		
LOT No: 1	DP No: 925163	SHEET: 13 OF 17		
STREET: 99 ISABELLA ST, WINGHAM				

**CLIENT:** CENITIC

			Date:	Rev
,	SCALE:		14.02.25	CONCEPT INITIAL
			18.02.25	CONCEPT REVISED
	SHEET SIZE:	A3	19.02.25	REVISED
	START DATE:	09.01.2023	11.03.25	DRAFT DA
	51116 11		18.03.25	REV DRAFT
	DWG No:	A5989	14.05.25	DA ISSUE

PERSPECTIVES

NZ STANDARDS, ENGINEERING & COUNCIL APPROVALS DRAWING REVISION + NOTES Revision: Issue: Drawn: CONCEPT INITIAL

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